

Topographic Survey St. Charles Borromeo

Being Lots 3-10, Block 21 of Hailey Townsite, Situate in the NW 1/4 of the SE 1/4 of Section 9, Township 2 North, Range 18 East, Boise Meridian City of Hailey, Blaine County, Idaho 2024

Vicinity Map:




Referenced Survey Table:

- R1. RECORD OF SURVEY INSTRUMENT #703181, RECORDS OF BLAINE COUNTY.
- R2. RECORD OF SURVEY INSTRUMENT #690043, RECORDS OF BLAINE COUNTY.
- R3. RECORD OF SURVEY INSTRUMENT #698696, RECORDS OF BLAINE COUNTY.

- ARE BASED UPON ABOVE GROUND EVIDENCE AND UTILITY COMPANY FACILITY MAPS. THE SURVEYOR MAKES NO GUARANTEE OF THE ACCURACY OF LOCATION OF UNDERGROUND UTILITIES. IT APPEARS AS ALL UNDER GROUND UTILITIES ARE LOCATED WITHIN THE RIGHT OF WAY OF THE 26-FOOT ALLEY.
- BOUNDARY INFORMATION SHOWN HEREON IS BASED ON RECORDS AVAILABLE TO THE SURVEYOR AT THE TIME OF SURVEY AND FOUND MONUMENTS ON THE GROUND. EASEMENTS, ENCROACHMENTS AND OTHER ENCUMBRANCES WHICH MAY BE APPARENT BY CONDUCTING A FULL TITLE SEARCH, ARE NOT
- SHOWN ARE HORIZONTAL GROUND DISTANCES IN U.S. SURVEY FEET.
- 4. AT THE TIME (JANUARY 26, 2024) OF THIS FIELD SURVEY THE ENTIRE SITE WAS COVERED WITH A BLANKET OF SNOW (SEVERAL INCHES), AND NUMEROUS PILES AND BERMS OF PLOWED SNOW WERE SHOWN ON THIS SURVEY. A RETURN TRIP MAY BE WARRANTED WHEN WEATHER AND SITE CONDITIONS

Legend:

- FOUND ALUMINUM CAP MONUMENT
- FOUND 1/2" REBAR, AS SHOWN FOUND MAG NAIL
- ◆ TEMPORARY BENCHMARK △ CALCULATED POINT, NOTHING FOUND OR SET
- WATER VALVE WATER METER
- FIRE HYDRANT
- FIRE DEPARTMENT CONNECTION
- RECTANGULAR INLET
- ROUND INLET AREA DRAIN
- SANITARY SEWER MANHOLE
- CLEAN OUT PRESSURE IRRIGATION VALVE
- GAS METER
- GAS VALVE
- O POWER POLE ☆ STREET LIGHT **E** ELECTRIC BOX

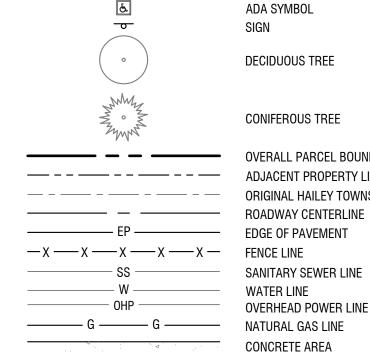


ELECTRIC METER

TELEPHONE RISER

CURB AND GUTTER


EXISTING BUILDING

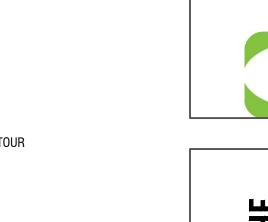




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Existing Conditions



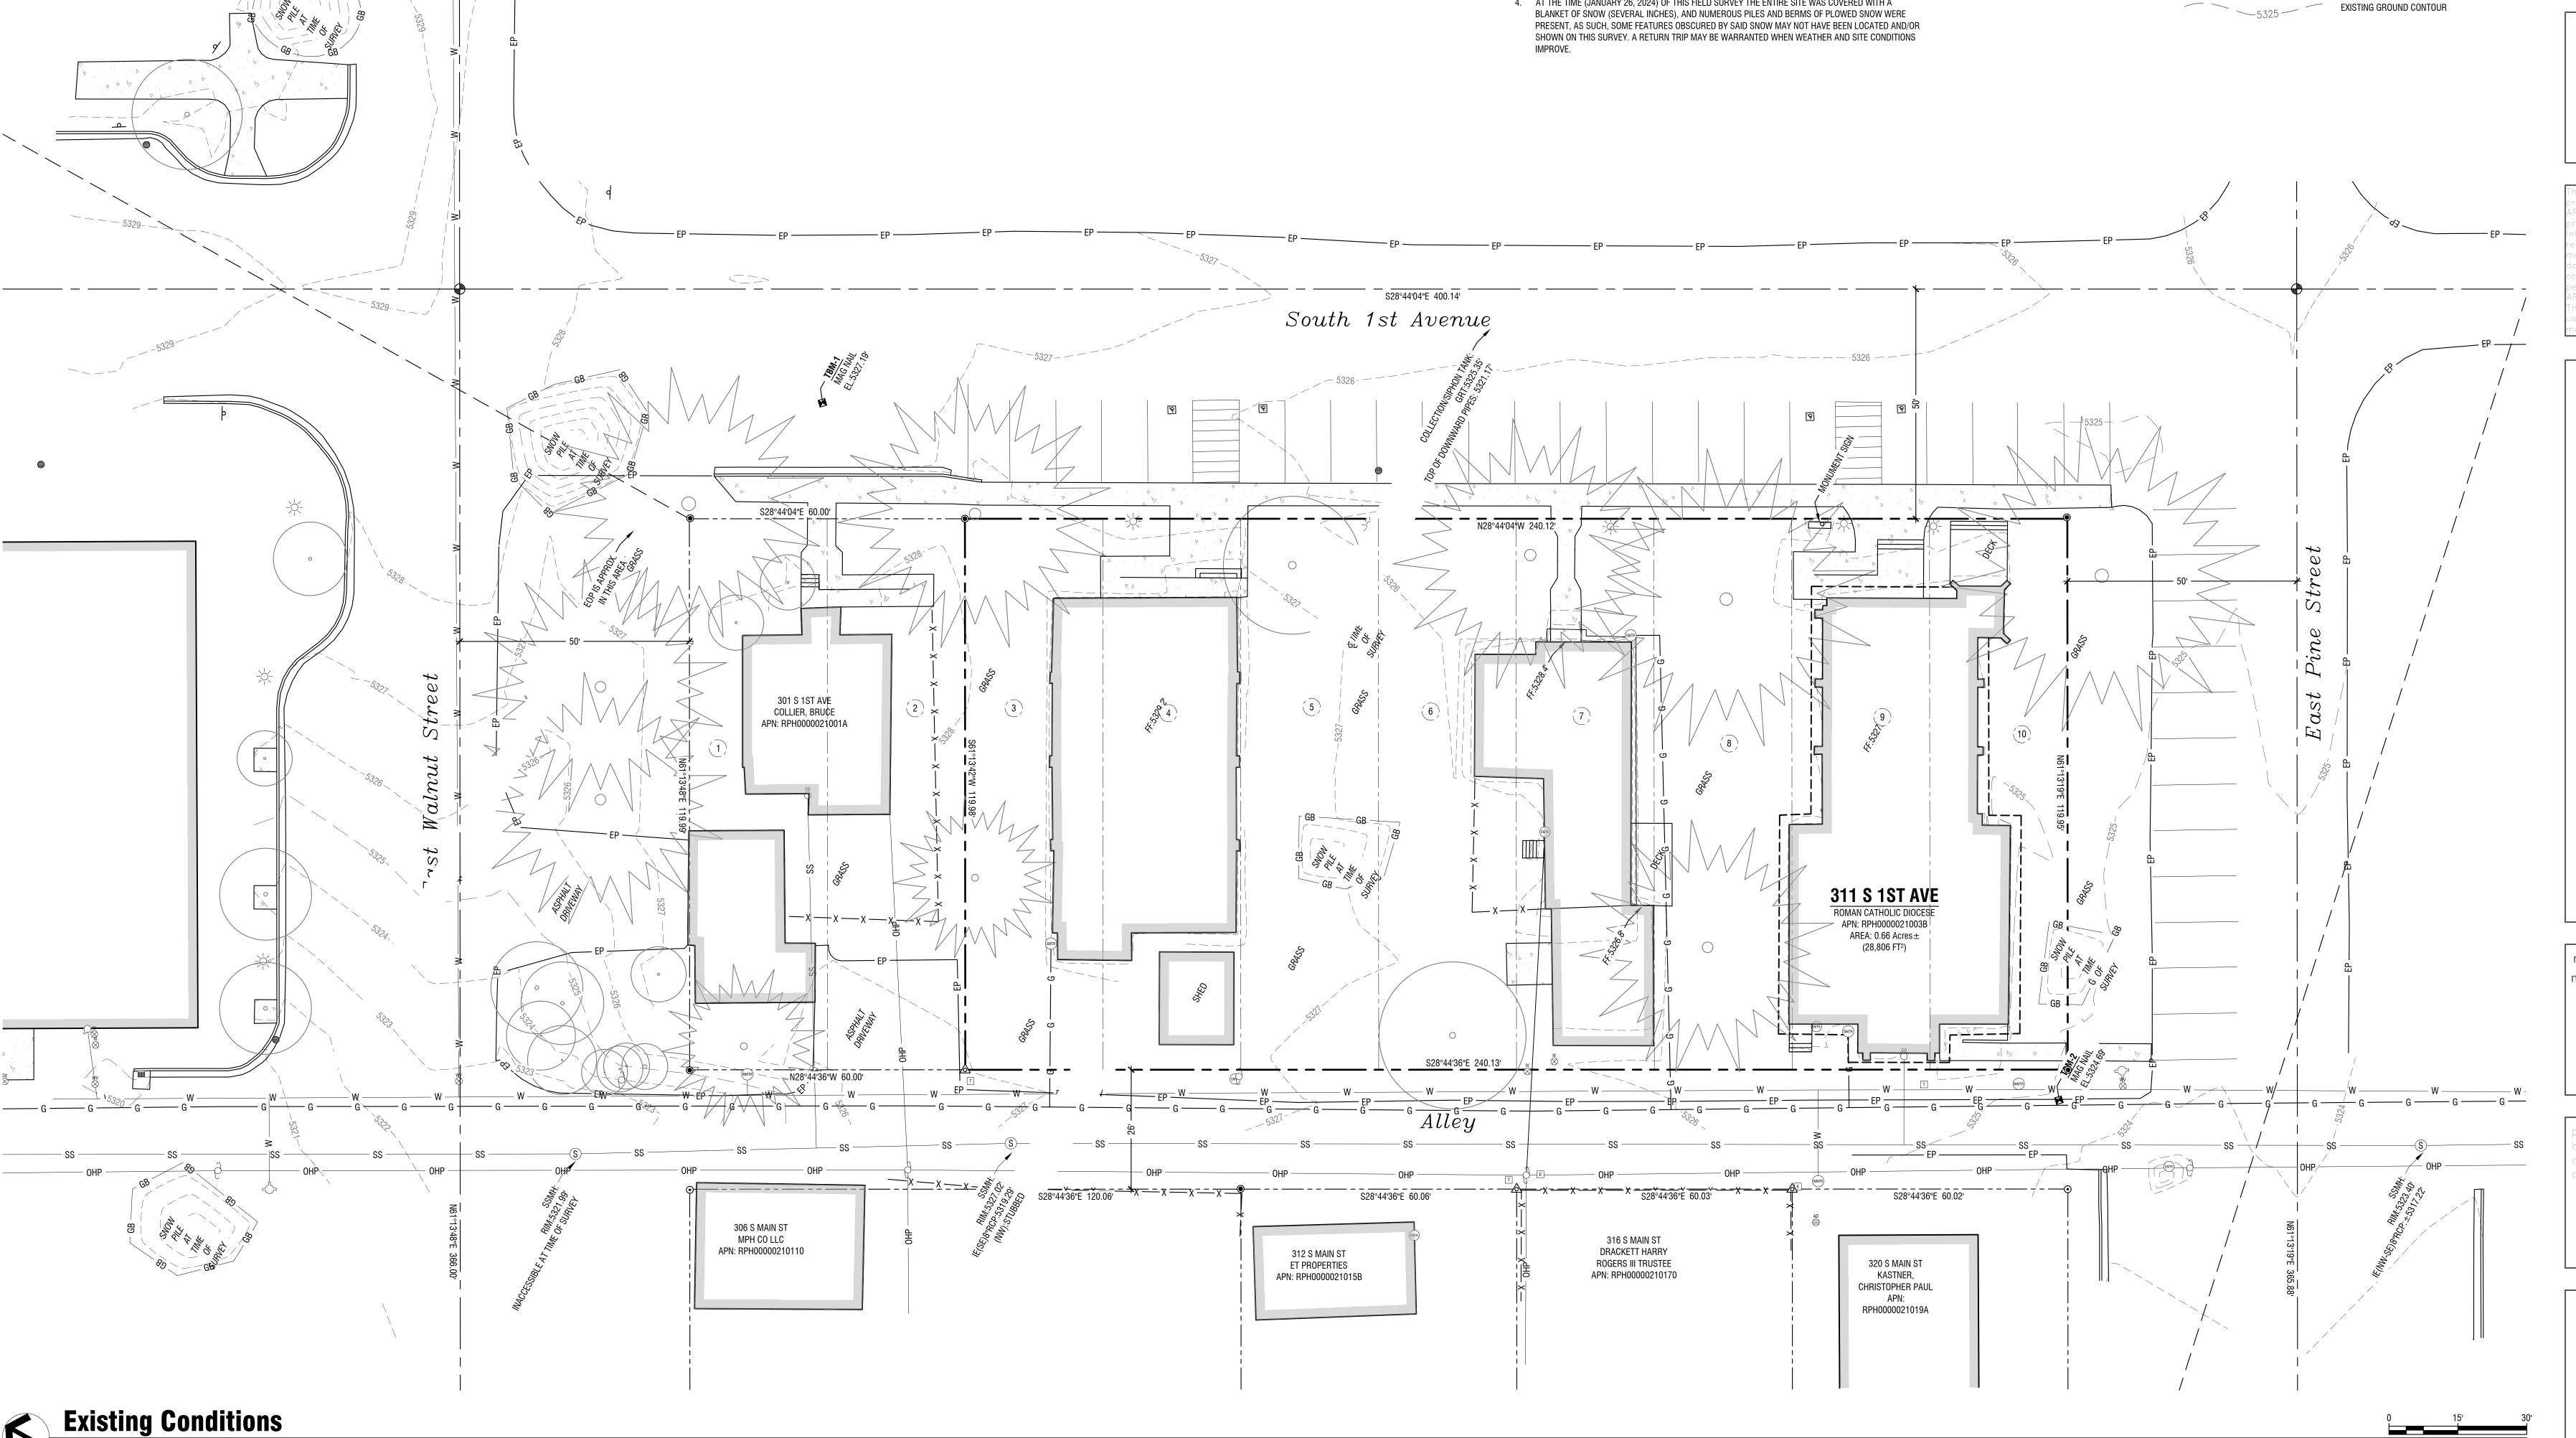

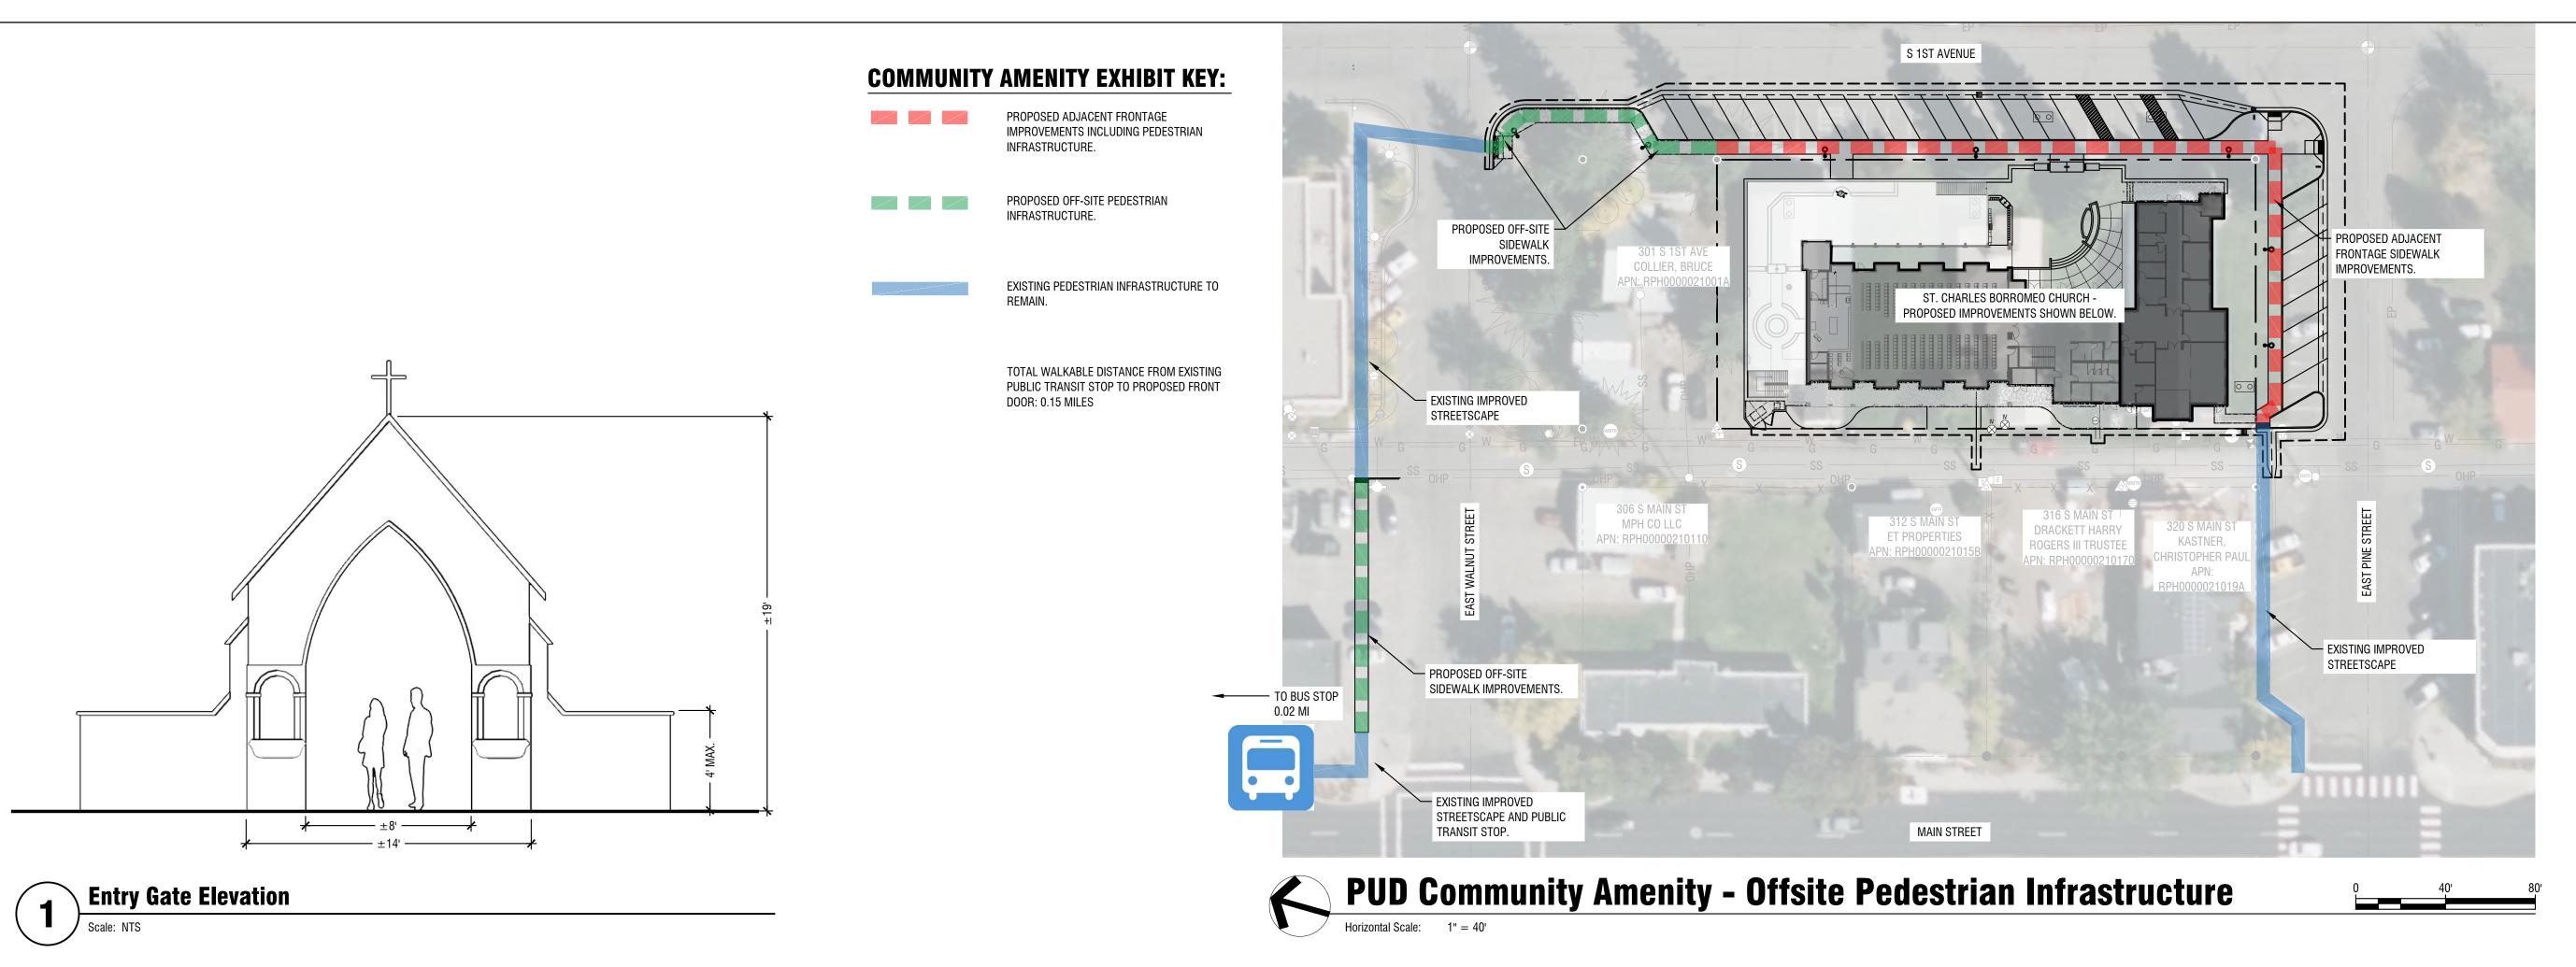Sheet Notes:

1. FOR LOWER COURTYARD SITE PLAN, SEE SHEET PUD 3.

. FOR GRADING, DRAINAGE AND UTILITIES, SEE SHEET PUD 5 & 6. 3. ALL DIMENSIONS ARE TO FACE OF CURB, EDGE OF WALK, EDGE OF PAVEMENT, EDGE OF FOUNDATION,

EDGE OF WALLS, CENTER OF WHEEL STOP OR CENTER OF POST. 4. SIDEWALK CROSS SLOPE CANNOT EXCEED 2%. NO TOLERANCES ALLOWED.

Material Legend:

ASPHALT PAVING IN CITY OF HAILEY R/W. MATCH EXISTING PAVEMENT SECTION. STANDARD CONCRETE FLATWORK. LANDSCAPE AREAS. REFER TO LANDSCAPE SHEETS PUD 6 & 7



FOR MORE INFORMATION.

OVERLAY)



CALLOUT NUMBERS COORDINATED TO NUMBERED NOTES BELOW.

1. TRASH ENCLOSURE

. MAIN ENTRY ARCH TO COURTYARD; SEE DETAIL 1/PUD 2

DROP-OFF AREA 4. PUBLIC SEATING AREA

5. DECORATIVE RETAINING WALL AND FENCE; HEIGHT SHALL BE NO GREATER THAN 4-FT ABOVE STREET LEVEL'S FINISHED GRADE.

BUILDING ENTRY 7. SHIELDED/DARK-SKY COMPLIANT STREET LIGHT

8. ADA RAMP WITH DETECTABLE WARNING STRIP


STREET SIGNAGE

STAIRS 11. OUTDOOR GATHERING SPACE

Code Compliance Data:

oud ouiipiiaiide bata.					
PARKING: RELIGIOUS INSTITUTION AS PRINCIPAL USE, 1 SPACE PER 5 SEATS.					
	EXISTING ON-SITE	0			
	EXISTING IN RIGHT-OF-WAY	33			
	REQUIRED (BASED ON 300 SEAT OCCUPANCY)	60			
	PROPOSED ON-SITE	3			
	PROPOSED IN RIGHT-OF-WAY	28			
	FRONT YARD BUILDING SETBACK	12-FT OCCUPIED STRUCTURE; 5-FT UNENCLOSED STRUCTURE (PER TOWNSITE OVERLAY)			
	SIDE YARD BUILDING SETBACK	10-FT (NORTH P/L PER TN ZONE); 12-FT (PINE PER TOWNSITE OVERLAY)			
	REAR YARD SETBACK (ALLEY ROW)	6-FT (PER TOWNSITE OVERLAY)			
	BUILDING HEIGHT	30-FT (PER TOWNSITE OVERLAY)			
	LOT COVERAGE	30% (PER TOWNSITE			

LOT COVERAGE

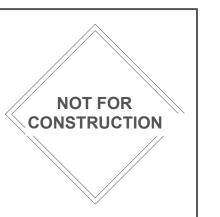






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Site Plan-**Main Level**




Site Plan- Lower Level

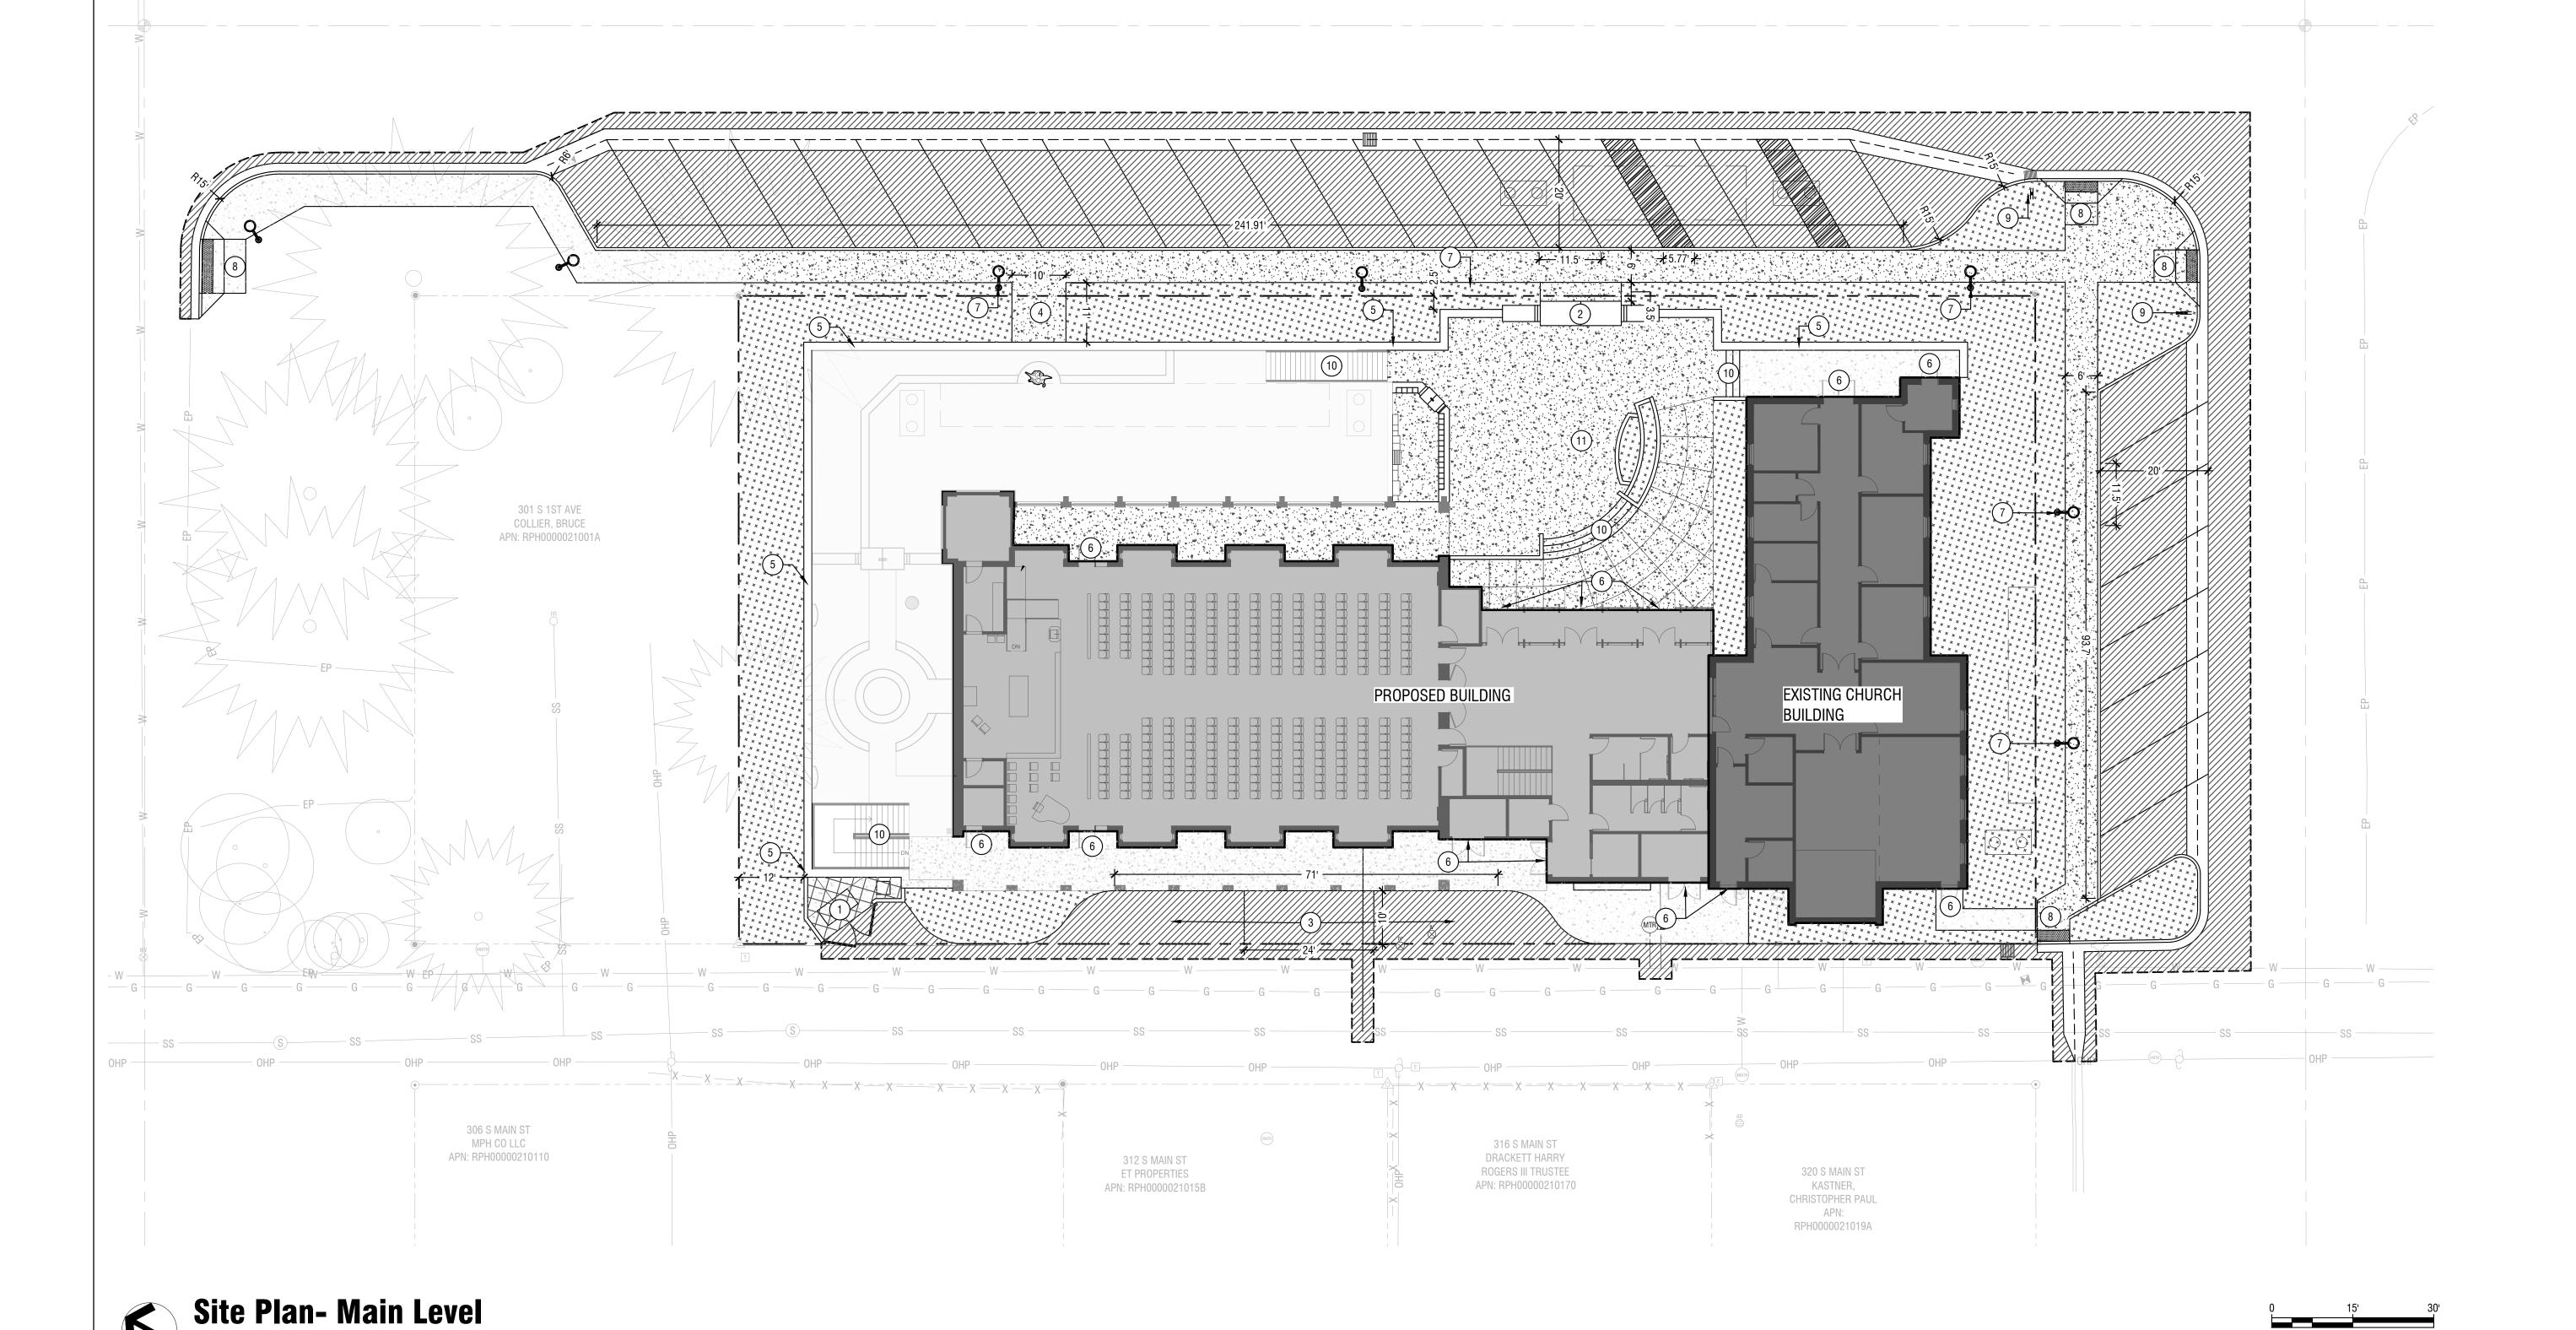Horizontal Scale: 1"= 15"


Sheet Notes:

- 1. FOR UPPER COURTYARD SITE PLAN, SEE SHEET PUD 2.
- 2. FOR GRADING, DRAINAGE AND UTILITIES, SEE SHEET PUD 5 & 6.
- 3. ALL DIMENSIONS ARE TO FACE OF CURB, EDGE OF WALK, EDGE OF PAVEMENT, EDGE OF FOUNDATION, EDGE OF WALLS, CENTER OF WHEEL STOP OR CENTER OF POST.
- 4. SIDEWALK CROSS SLOPE CANNOT EXCEED 2%. NO TOLERANCES ALLOWED.

Material Legend:

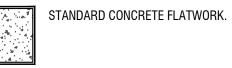



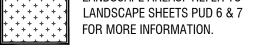

Keynotes:

CALLOUT NUMBERS COORDINATED TO NUMBERED NOTES BELOW.

- TRASH ENCLOSURE 2. MAIN ENTRY ARCH TO COURTYARD; SEE DETAIL 1/PUD 2
- DROP-OFF AREA 4. PUBLIC SEATING AREA
- 5. DECORATIVE RETAINING WALL AND FENCE; HEIGHT SHALL BE NO GREATER THAN 4-FT ABOVE STREET LEVEL'S FINISHED GRADE.
- BUILDING ENTRY
- 7. SHIELDED/DARK-SKY COMPLIANT STREET LIGHT 8. ADA RAMP WITH DETECTABLE WARNING STRIP
- 9. STREET SIGNAGE
- 10. STAIRS 11. OUTDOOR GATHERING SPACE



NOT FOR

CONSTRUCTION




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Site Plan-**Lower Level**



KASTNER,

CHRISTOPHER PAUL

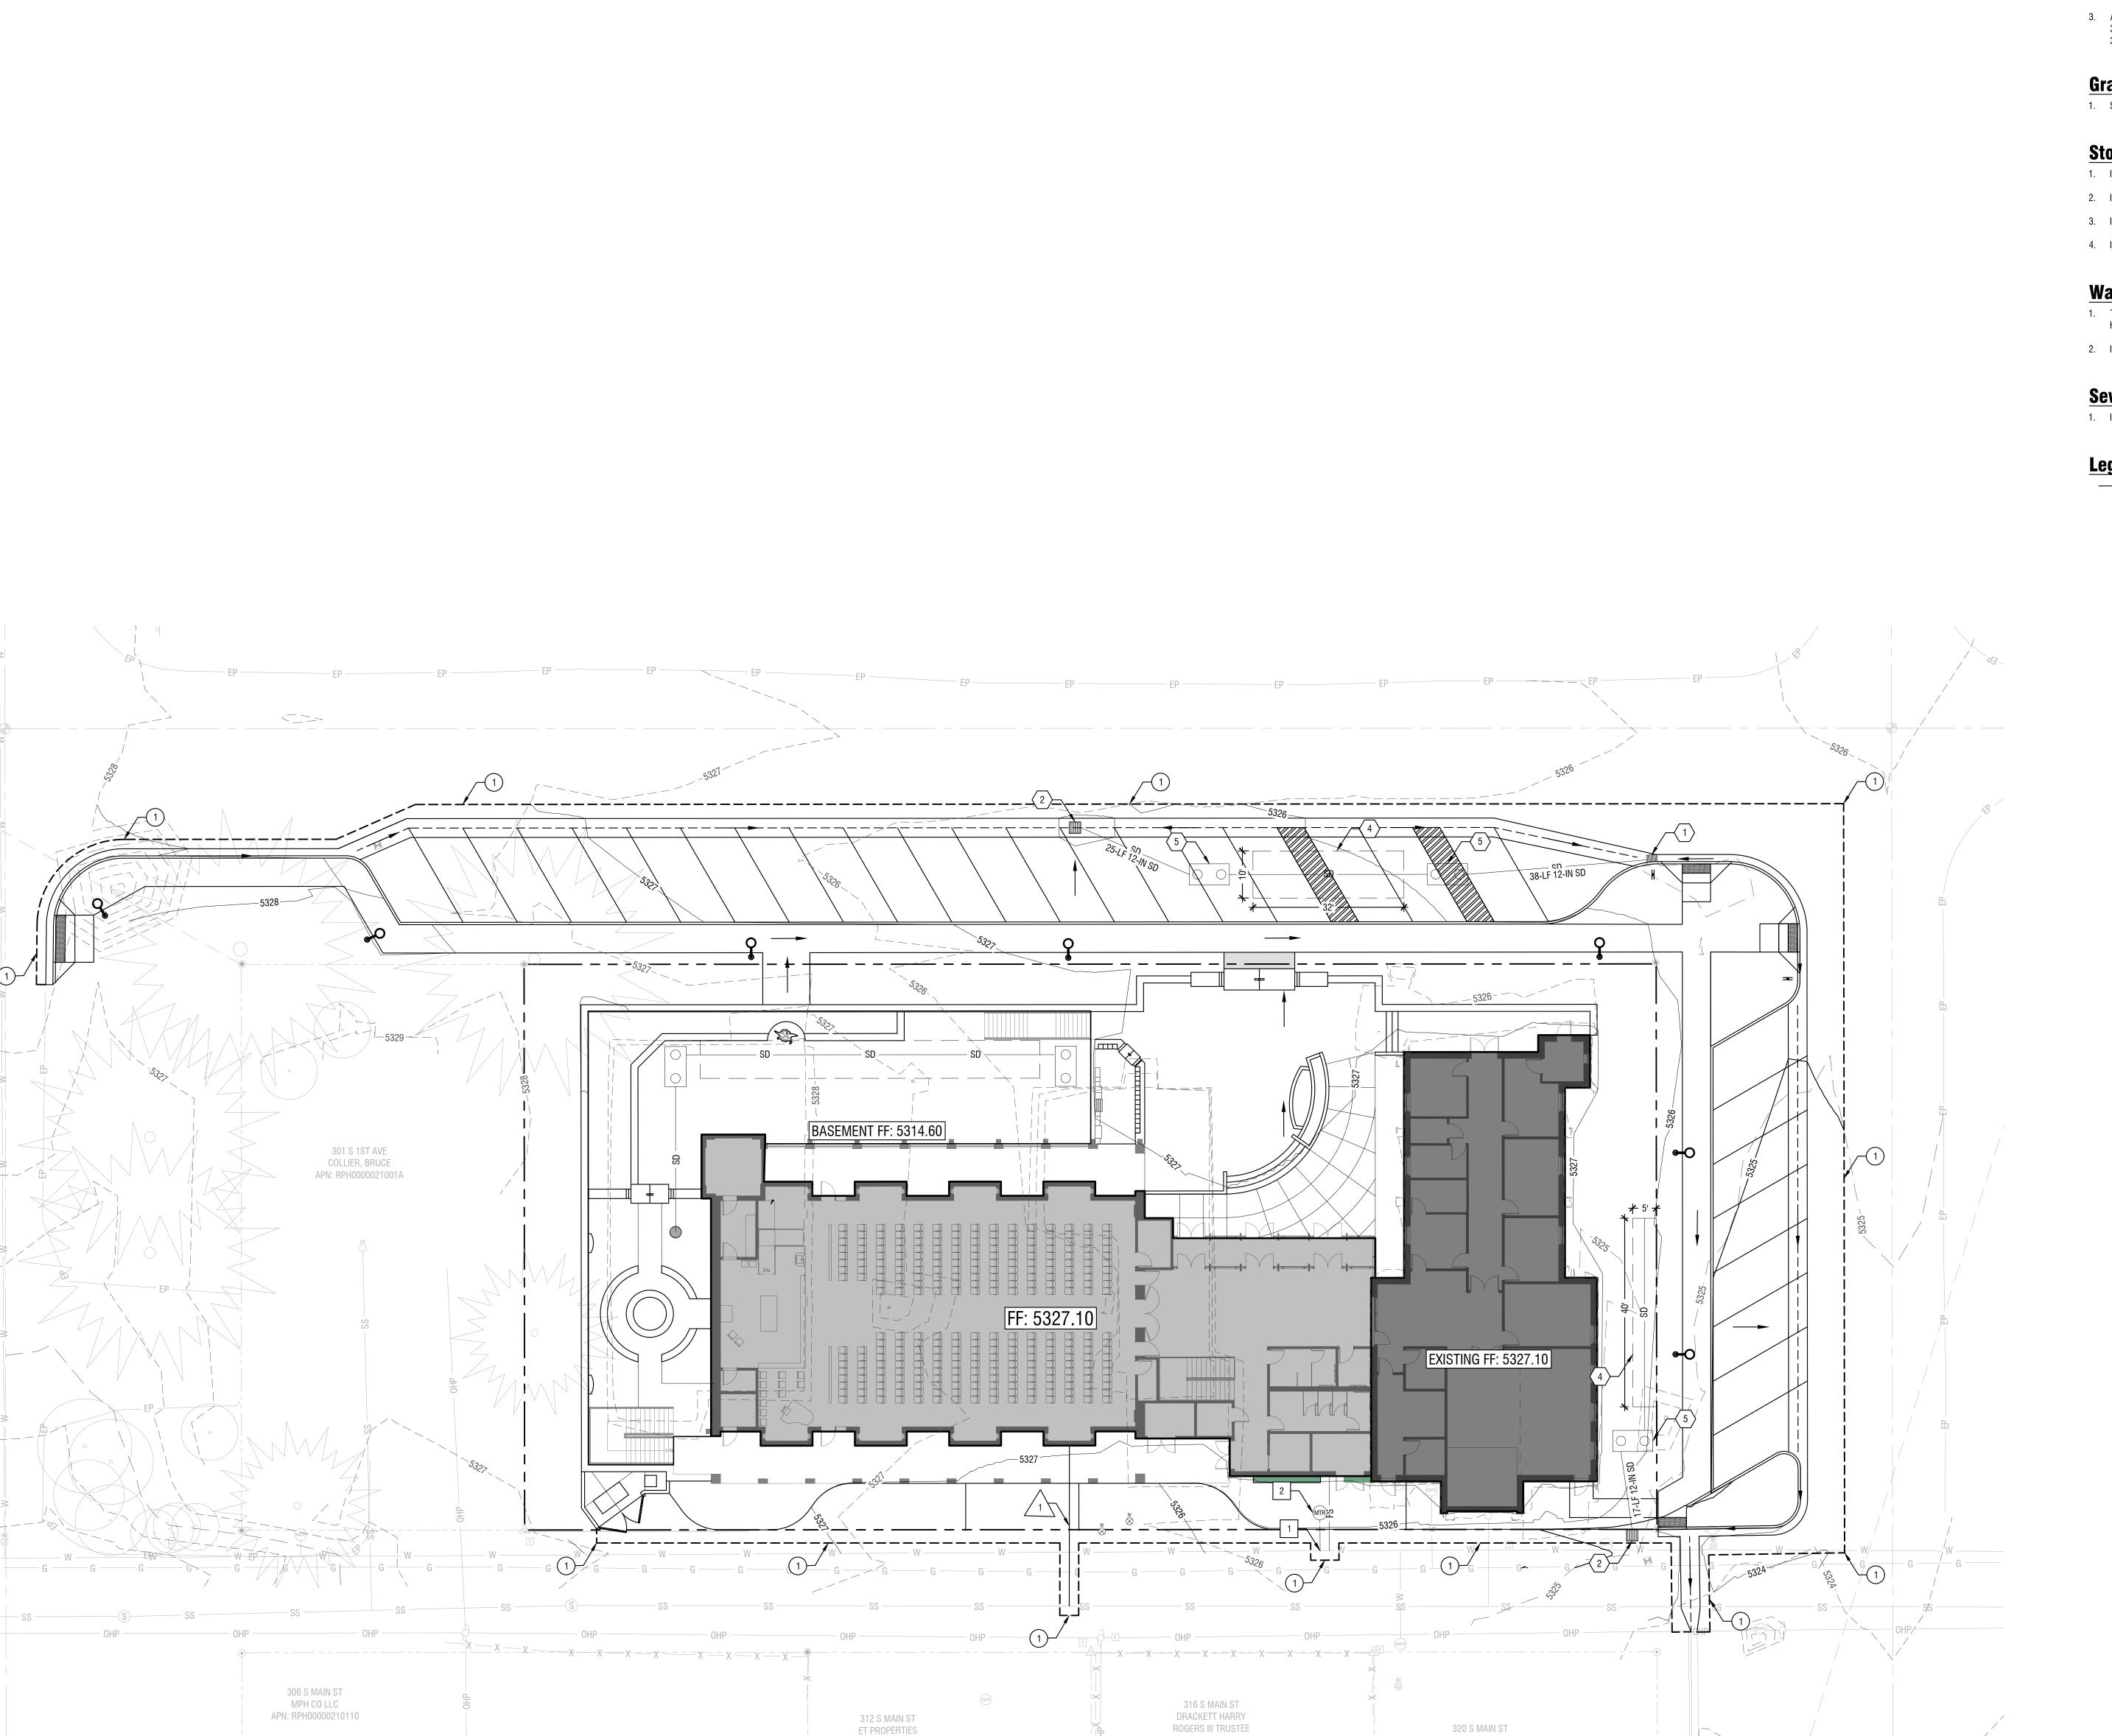APN: RPH0000021019A

APN: RPH00000210170

APN: RPH0000021015B

Grading and Drainage Plan- Main Level

Sheet Notes:

- 1. LONGITUDINAL SLOPE OF ALL SIDEWALKS SHALL NOT EXCEED 5%. CROSS SLOPE SHALL NOT EXCEED 2%. SLOPES WITHIN PEDESTRIAN RAMPS SHALL NOT EXCEED 12:1 SLOPE IN ANY DIRECTION. FLATWORK ADJACENT TO BUILDING SHALL NOT EXCEED 2% CROSS SLOPE OR HAVE CROSS SLOPE LESS THAN 1%.
- 2. SPOT ELEVATIONS INDICATE TOP OF FINISH GRADE SURFACE AS NOTED BY THE FOLLOWING:

 FF = FINISHED FLOOR
- 3. ALL PIPE INSTALLATION AND TRENCHING SHALL COORDINATE WITH ISPWC DIVISION 300 AND SD-301. BEDDING AND BACKFILL SHALL BE CONSTRUCTED PER SECTIONS 305 AND 306 OF THE ISPWC.

Grading Keynotes:

CALLOUT NUMBERS COORDINATED TO NUMBERED NOTES BELOW.

SAWCUT PER ISPWC SD-303. PROVIDE A NEAT AND SMOOTH SAWCUT LINE.

Storm Keynotes:

CALLOUT NUMBERS COORDINATED TO NUMBERED NOTES BELOW.

- 1. INSTALL CATCH BASIN TYPE 1 PER ISPWC SD-601.
- 2. INSTALL 30-INCH ROUND CATCH BASIN WITH A SQUARE $\underline{\textit{GRATED}}$ LID .
- 3. INSTALL STORM WATER SEEPAGE BED.
- 4. INSTALL SAND AND GREASE TRAP.

Water Keynotes:

CALLOUT NUMBERS COORDINATED TO NUMBERED NOTES BELOW.

- 1. TAP WATER SERVICE FROM EXISTING WATER MAIN. COORDINATE WITH CITY OF HAILEY WATER DEPARTMENT.
- 2. INSTALL WATER METER PER ISPWC AND CITY OF HAILEY REQUIREMENTS.

Sewer Keynotes:


CALLOUT NUMBERS COORDINATED

TO NUMBERED NOTES BELOW.

1. INSTALL SANITARY SEWER SERVICE PER ISPWC SD-511.

Legend:

DRAINAGE DIRECTIONAL ARROW

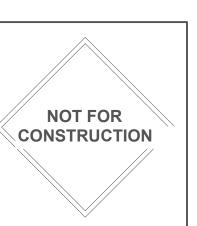





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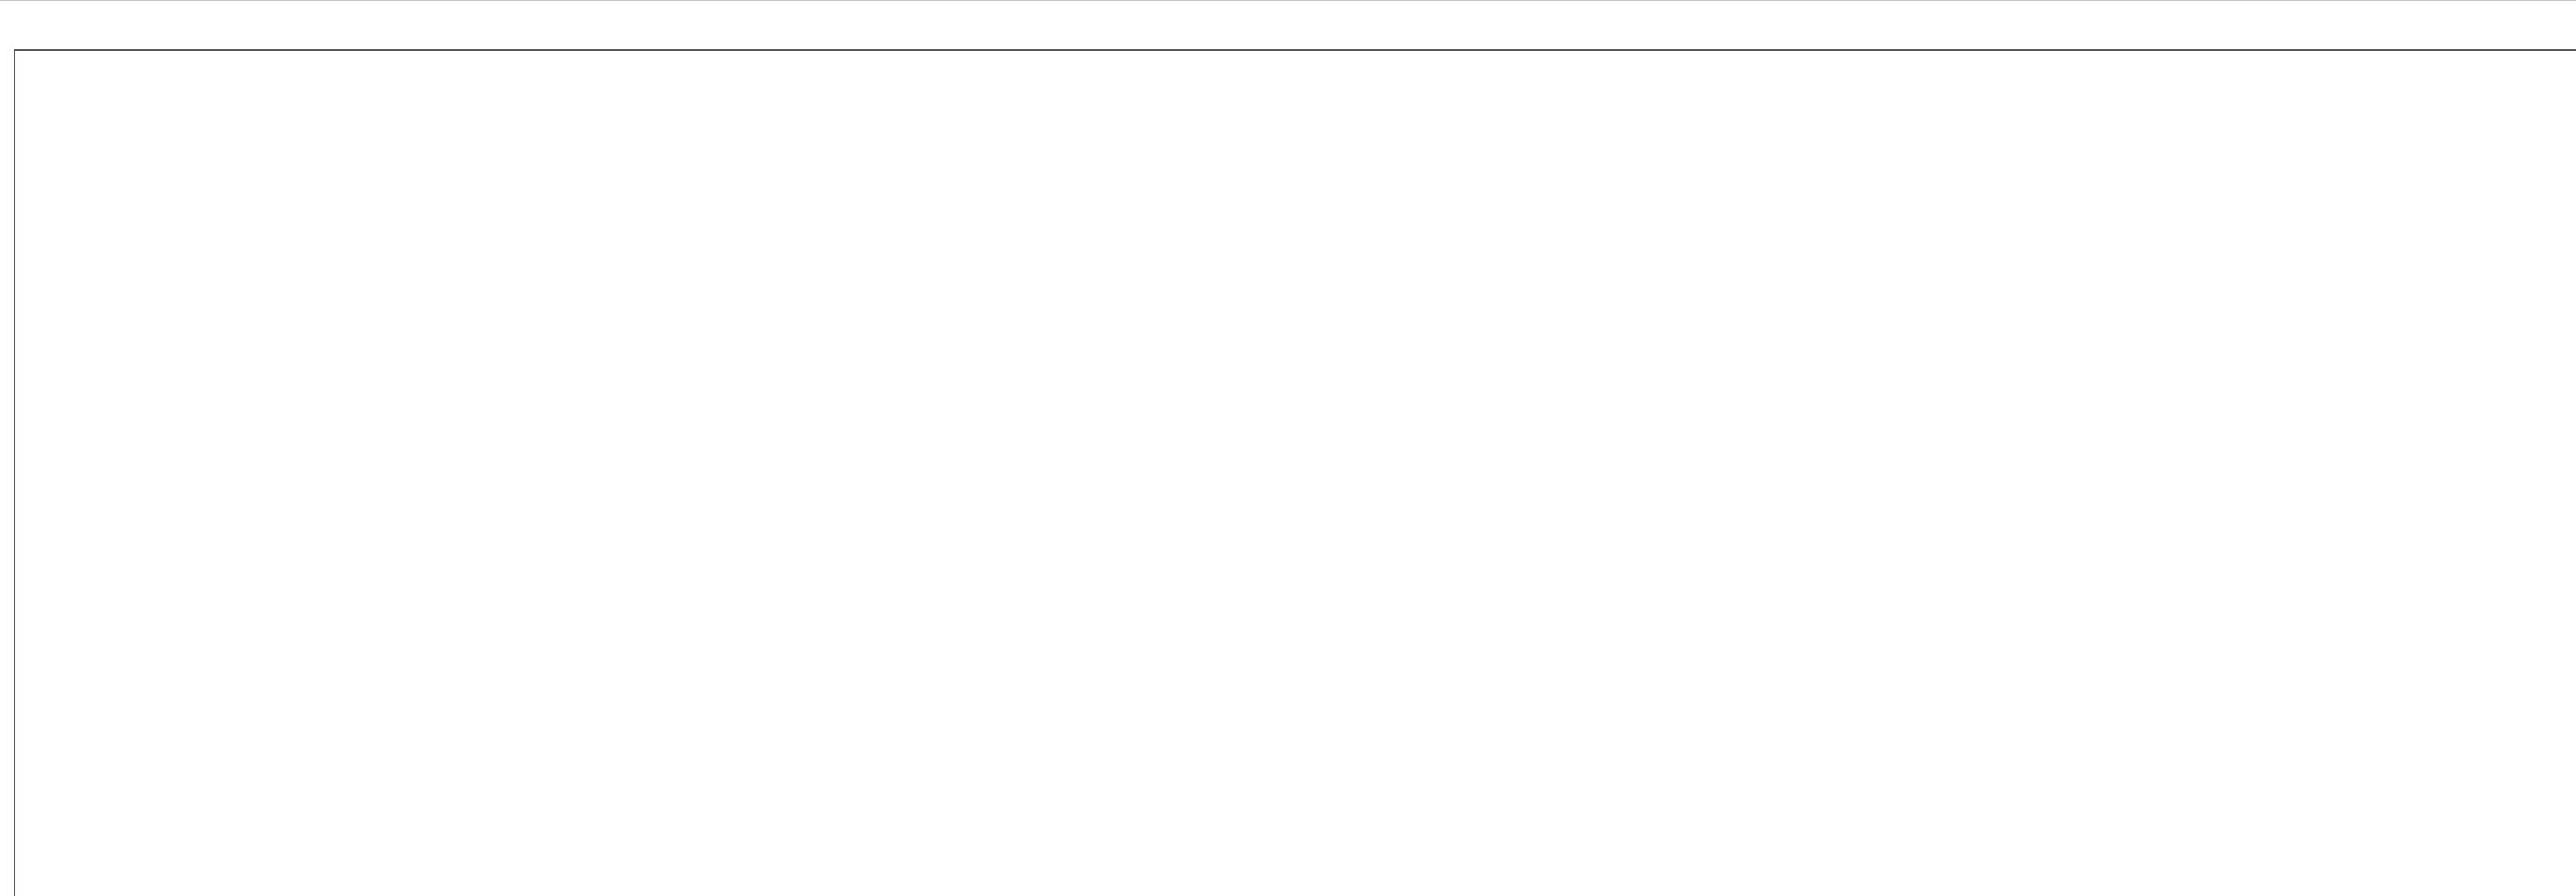
Charles Borromeo

desc.

project: 230706 date: 12.19.24 drawn: KW/CL/⁻ checked: MTA

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Grading and
Grading
and
and
Drainage
PlanMain
Level



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- 2. INSTALL 30-INCH ROUND CATCH BASIN WITH A SQUARE *GRATED* LID .
- 3. INSTALL 30-INCH ROUND CATCH BASIN WITH A ROUND <u>GRATED</u> LID.
- 4. INSTALL STORM WATER SEEPAGE BED.
- 5. INSTALL SAND AND GREASE TRAP.

Water Keynotes:

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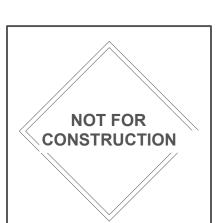
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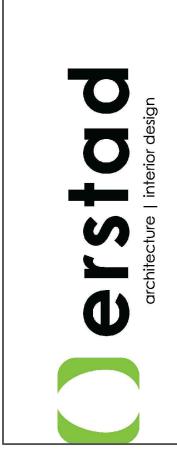
2. INSTALL WATER METER PER ISPWC AND CITY OF HAILEY REQUIREMENTS.


Sewer Keynotes: #\TO NUMBERED NOTES BELOW.

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DRAINAGE DIRECTIONAL ARROW





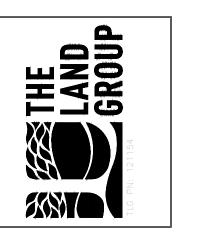


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Grading and Drainage Plan- Lower Level




PLANT	SCH	EDULE			
SYMBOL	CODE	BOTANICAL / COMMON NAME	SIZE	CONTAINER	QTY
CLASS I TREES					
4 + 4 + 4 + 4 + 4 + 4 + 4 + 4 + 4 + 4 +	AG	AMELANCHIER X GRANDIFLORA 'AUTUMN BRILLIANCE' / AUTUMN BRILLIANCE APPLE SERVICEBERRY 15' HGT; 15' SPD	2" CAL.	B&B	1
	CI	CRATAEGUS CRUS-GALLI INERMIS / THORNLESS COCKSPUR HAWTHORN 25' HGT; 20' SPD	2.5" CAL.	B&B	1
CLASS II TREES					•
	AC	ACER PLATANOIDES 'CRIMSON KING' / CRIMSON KING NORWAY MAPLE 40' HGT; 30' SPD	2.5" CAL.	B&B	1
	GA	GINKGO BILOBA `AUTUMN GOLD` / AUTUMN GOLD MAIDENHAIR TREE 50' HGT; 30' SPD	2.5" CAL.	B&B	4
0	QE	QUERCUS X `CRIMSCHMIDT` / CRIMSON SPIRE™ OAK 40' HGT; 15' SPD	2.5" CAL.	B&B	2
CLASS III TREES	3				
	GD	GYMNOCLADUS DIOICUS `ESPRESSO` / KENTUCKY COFFEETREE 50' HGT; 35' SPD	2.5" CAL.	B&B	4
CONIFERS					
Sandruga San	AL	ABIES LASIOCARPA / SUBALPINE FIR 50' HGT; 20' SPD	8` HT.	B&B	2
* * * * * * * * * * * * * * * * * * * *	PF	PINUS FLEXILIS `VANDERWOLF`S PYRAMID` / VANDERWOLF`S PYRAMID LIMBER PINE 25' HGT; 15' SPD	8` HT.	B&B	3

PLAN	IT S	CHEDULE			
SYMBOL	CODE	BOTANICAL / COMMON NAME	SIZE	CONTAINER	QTY
SHRUBS					
\bigcirc	СМ	CORNUS SANGUINEA 'MIDWINTER FIRE' / MIDWINTER FIRE BLOODTWIG DOGWOOD	3 GAL.		7
	cs	CORNUS SERICEA 'CARDINAL' / CARDINAL RED TWIG DOGWOOD 6' HGT; 8' SPD	3 GAL.	POT	8
	РВ	PHILADELPHUS LEWISII 'BLIZZARD' / BLIZZARD MOCK ORANGE 4' HGT; 3' SPD	5 GAL.	РОТ	2
\odot	RG	RHUS AROMATICA 'GRO-LOW' / GRO-LOW FRAGRANT SUMAC 2' HGT; 6' SPD	3 GAL.	РОТ	12

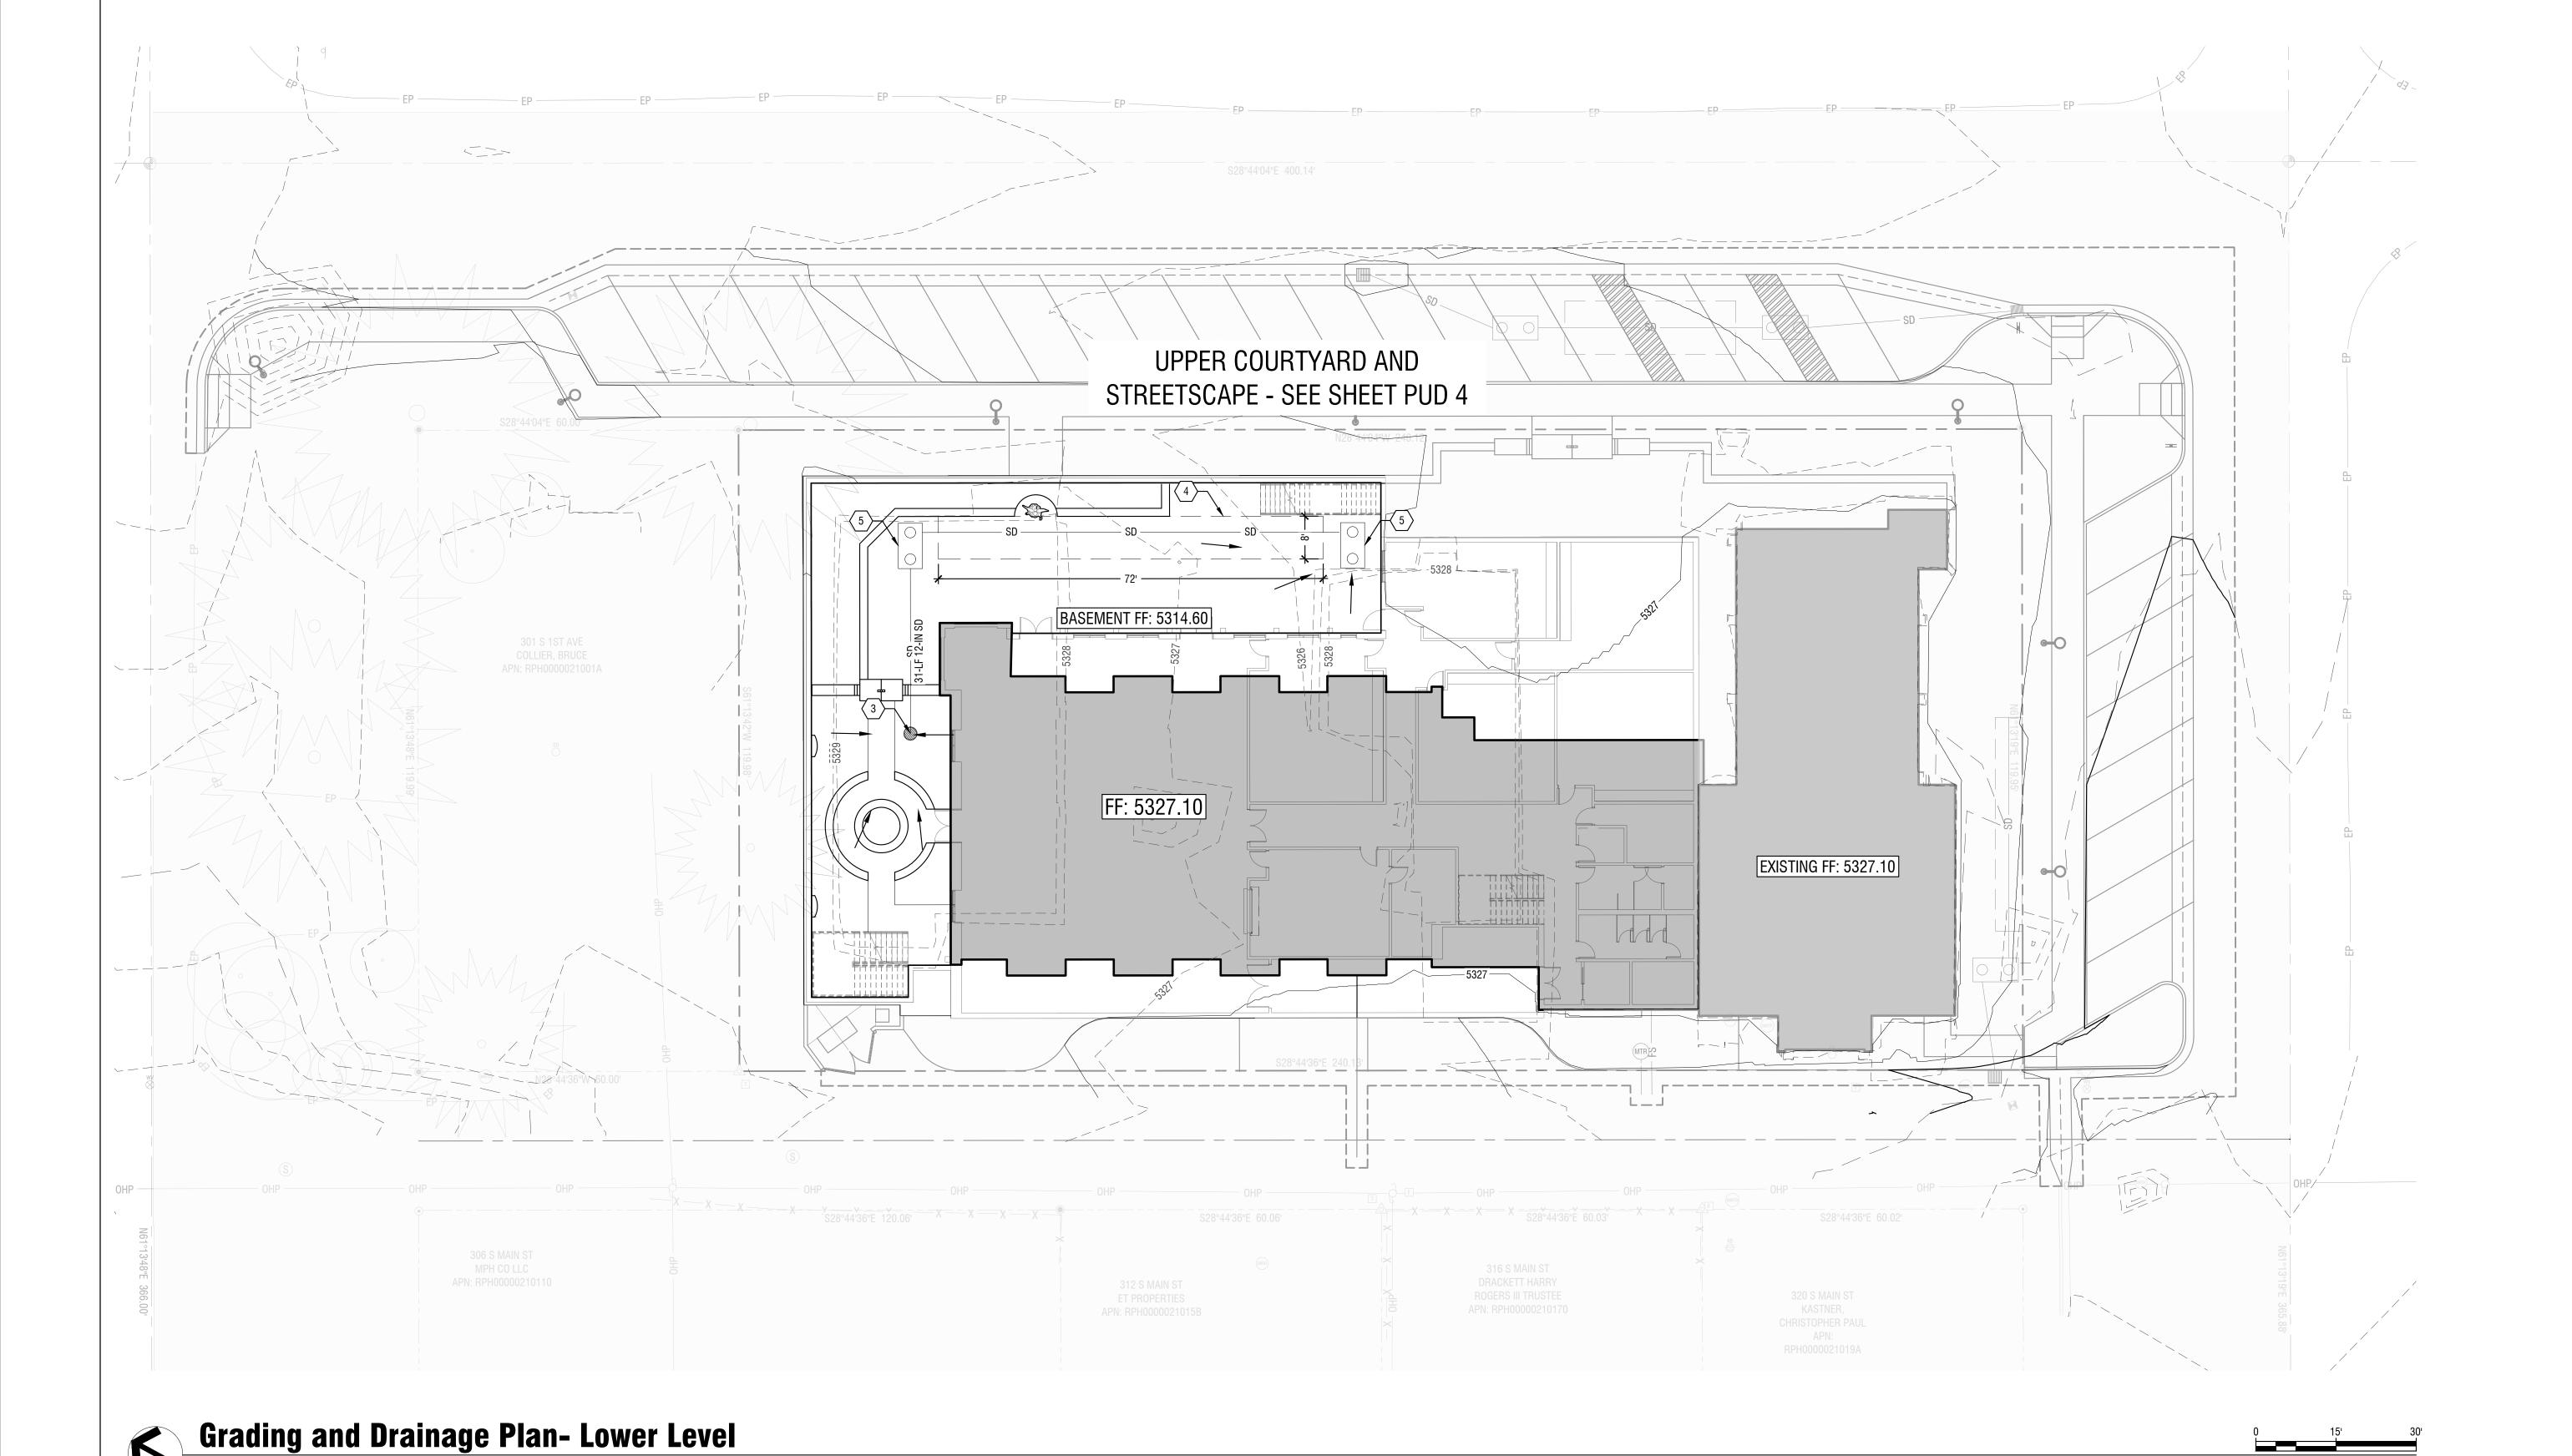SPECIES	MATURE SIZE	NURSERY STOCK SIZE
BOUTELOUA GRACILIS 'BLONDE AMBITION' / BLONDE AMBITION BLUE GRAMA GRASS	3' HGT; 3' SPD	2 GAL
CENTRANTHUS RUBER RED VALERIAN	3' HGT; 2' SPD	1 GAL
ECHINACEA PURPUREA 'FRAGRANT ANGEL' FRAGRANT ANGEL CONEFLOWER	4' HGT; 2' SPD	1 GAL
CALAMINTHA NEPATA CALAMINT	2' HGT; 2' SPD	1 GAL
SALVIA PACHYPHYLLA GIANT FLOWERED PURPLE SAGE	3' HGT; 3' SPD	1 GAL
SALVIA X SYLVESTRIS ' MAY NIGHT' MAY NIGHT SAGE	2' HGT; 2' SPD	1 GAL
LIATRIS SPICATA BLAZING STAR	3' HGT; 2' SPD	1 GAL
PENSTEMON X MEXICAL 'P008S' RED ROCKS PENSTEMON	3' HGT; 3' SPD	1 GAL
PANICUM VIRGATUM "SHENANDOAH' SHENANDOAH SWITCH GRASS	4' HGT; 3' SPD	2 GAL
NEPETA X FAASSENII 'WALKER'S LOW' WALKER'S LOW CATMINT	2' HGT; 4' SPD	2 GAL
SPOROBOLUS HETEROLEPIS PRAIRIE DROPSEED	3' HGT; 2' SPD	2 GAL
PENNISETUM ALOPECUROIDES 'HAMELN' HAMELN FOUNTAIN GRASS	3' HGT; 3' SPD	2 GAL
SCHIZACHYRIUM SCOPARIUM LITTLE BLUESTEM	3' HGT; 2' SPD	2 GAL

PERENNIAL AND FORB PALETTE - FULL SUN

SPECIES	MATURE SIZE	NURSERY STOC SIZE
HEUCHERA X 'PARIS' PARIS CORAL BELLS	2' HGT; 2' SPD	1 GAL
HOSTA X 'BLUE ANGEL' BLUE ANGEL HOSTA	3' HGT; 4' SPD	2 GAL
IRIS SIBIRICA SIBERIAN IRIS	3' HGT; 2' SPD	1 GAL
CAREX PENNSYLVANICA PENNSYLVANIA SEDGE	1' HGT; 2' SPD	1 GAL
PLATYCODON GRANDIFLORUS BALLOON FLOWER	2' HGT; 2' SPD	1 GAL
POLEMONIUM CAERULEUM JACOB'S LADDER	2' HGT; 2' SPD	1 GAL
POLYSTICHUM MUNITUM WESTERN SWORD FERN	3' HGT; 3' SPD	2 GAL
SYMPHYOTRICHUM OBLONGIFOLIUM FALL ASTER	4' HGT; 2' SPD	1 GAL
HELLEBORUS X 'WALHELIVOR' IVORY PRINCE HELLEBORE	2' HGT; 2' SPD	1 GAL
DESCHAMPSIA CESPITOSA TUFTED HAIR GRASS	3' HGT; 2' SPD	2 GAL

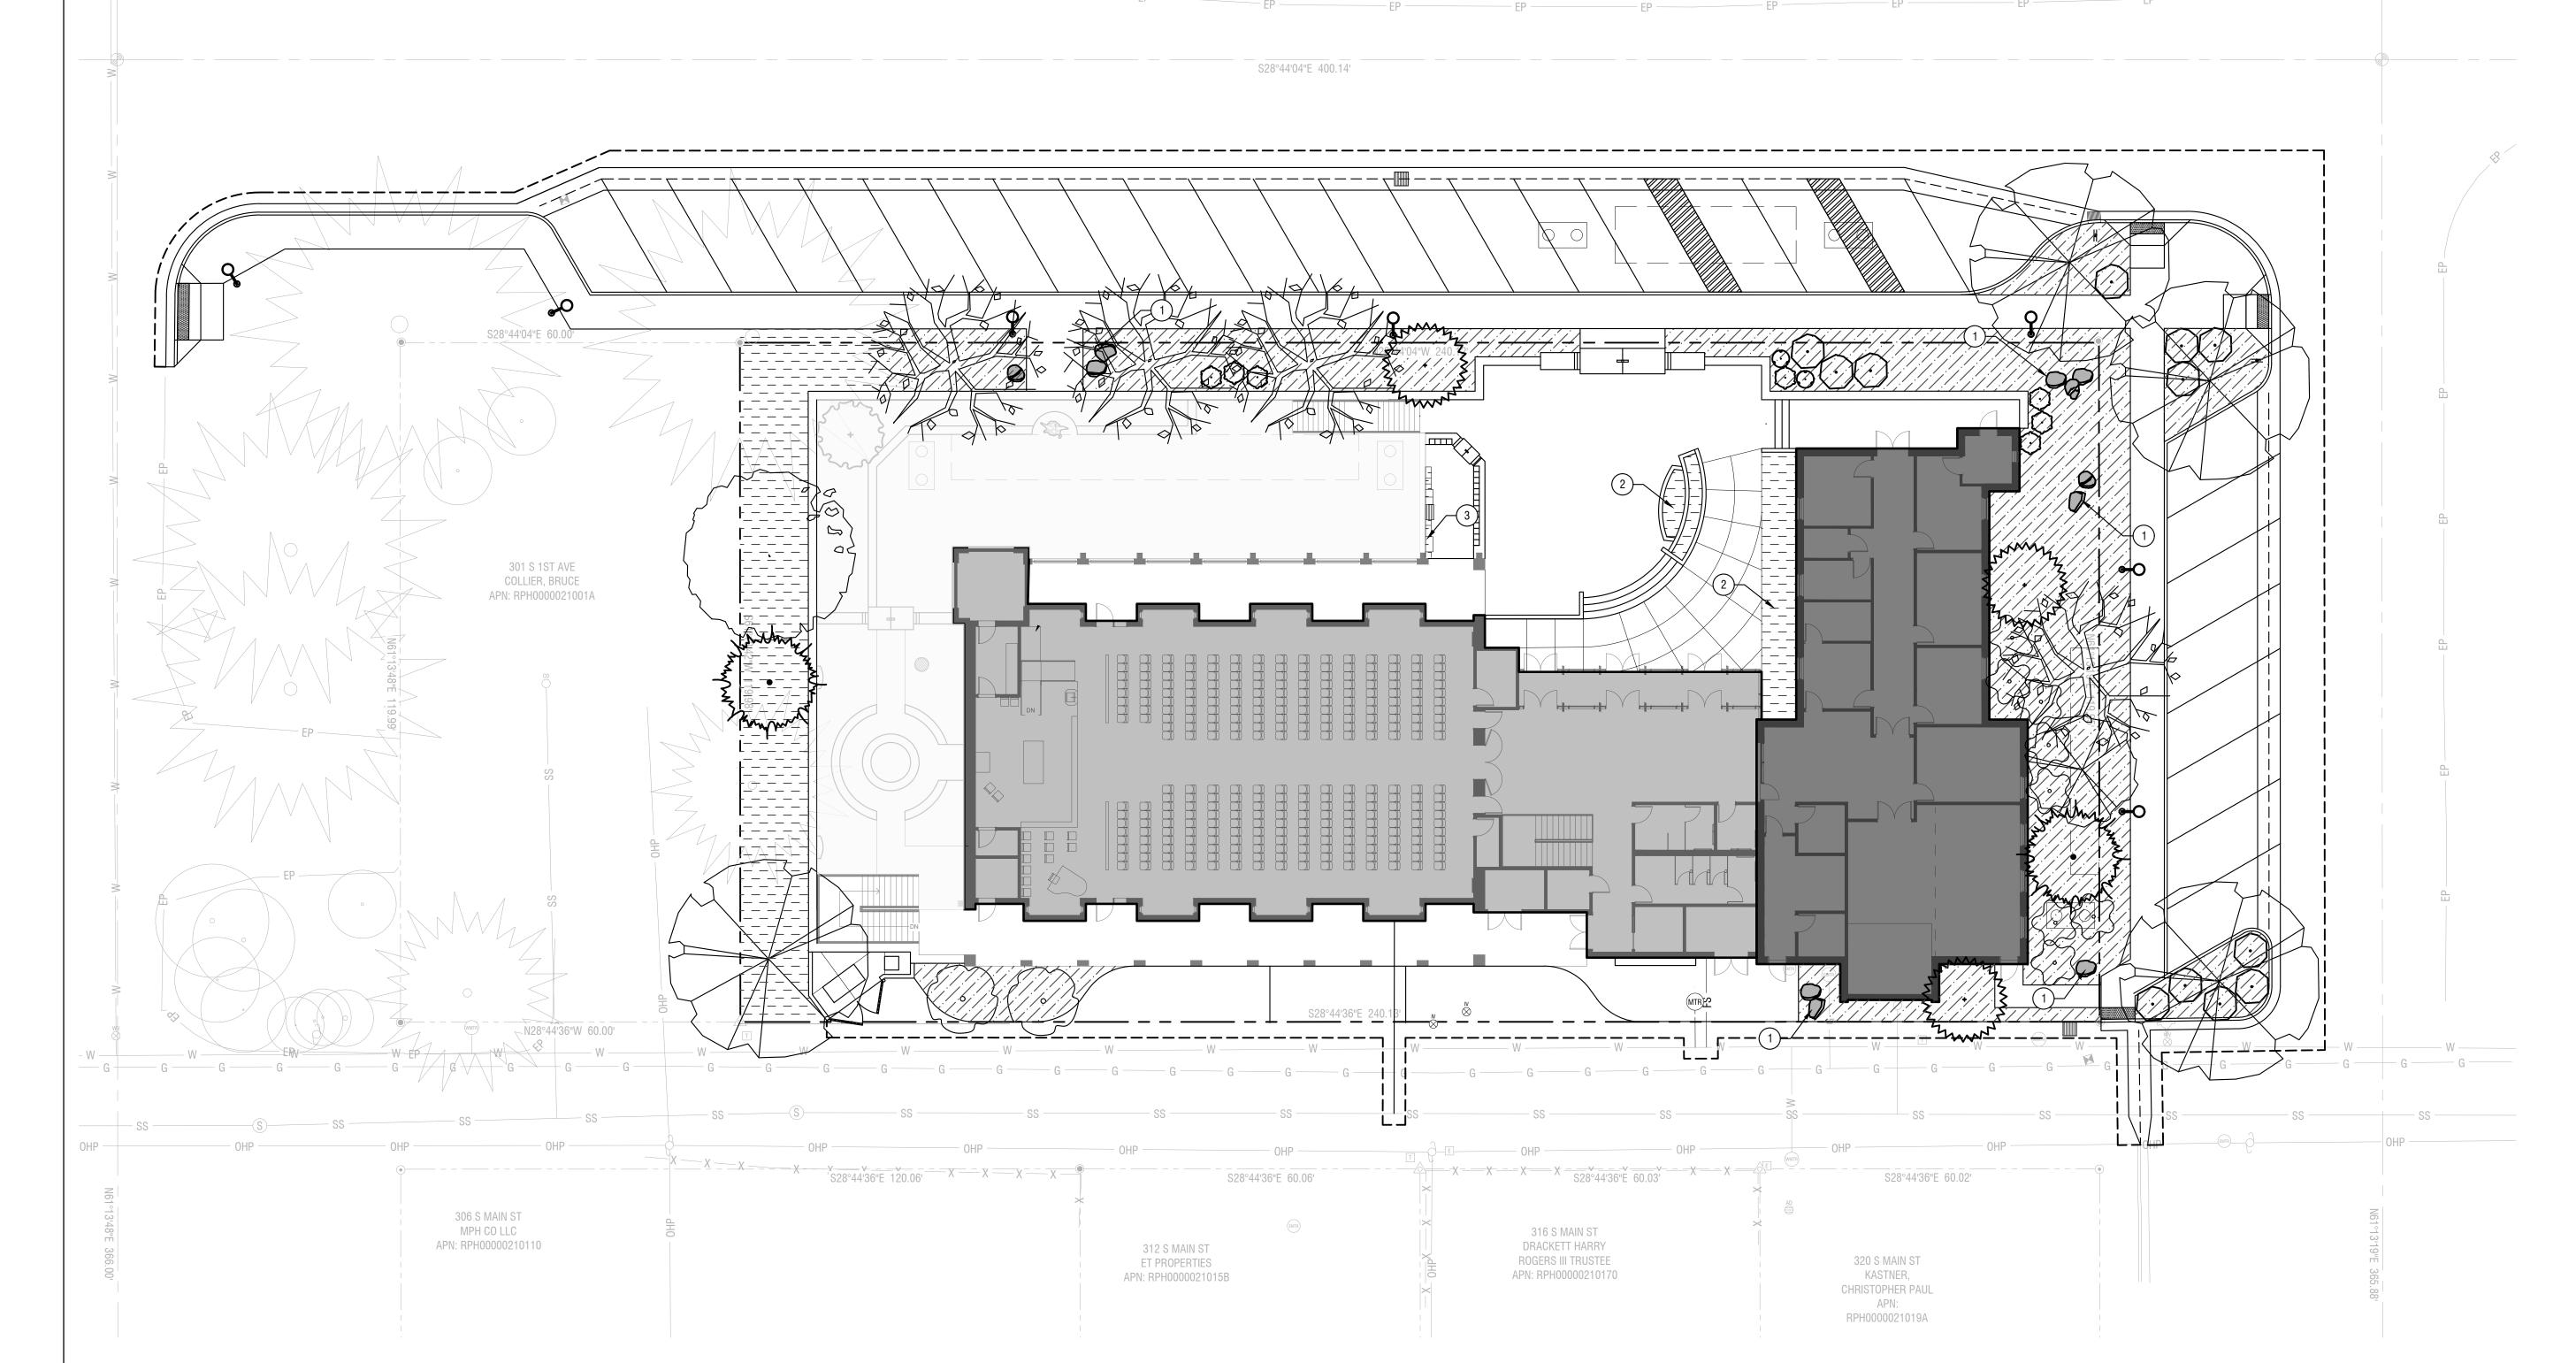


Sheet Notes:

1. FOR LOWER COURTYARD LANDSCAPE PLAN, SEE SHEET PUD 7.

2. FOR EXISTING TREE INVENTORY, SEE SHEET PUD 8.

Material Legend:

PLANTER WITH MULCH AT 3" DEPTH; FULL SUN PERENNIAL/FORB PALETTE.

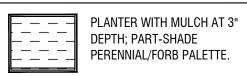



CALLOUT NUMBERS COORDINATED TO NUMBERED NOTES BELOW.

3. RAISED PLANTER AND INTEGRAL BENCH.

1. SANDSTONE BOULDER. INSTALL PER DETAIL 4/PUD 7. RAISED PLANTER.

Landscape Notes:

- A. CONTRACTOR SHALL REPORT TO LANDSCAPE ARCHITECT ALL CONDITIONS WHICH IMPAIR AND/OR PREVENT THE PROPER EXECUTION OF THIS WORK, PRIOR TO BEGINNING WORK. B. FINISH GRADES TO BE SMOOTH AND EVEN GRADIENTS WITH POSITIVE DRAINAGE IN ACCORDANCE WITH SITE GRADING PLAN. REMOVE RIDGES AND FILL DEPRESSIONS, AS REQUIRED TO MEET FINISH GRADES. PLACE 3" OF MULCH OVER SUBGRADE SOIL TO ACHIEVE FINISH GRADE. FINISH GRADE RELATED TO ADJACENT SITE
- ELEMENTS SHALL BE: B.A. 1-INCH BELOW TOP OF ADJACENT PAVEMENT, VALVE BOX, VAULT, ETC.
- B.B. 3-INCHES BELOW TOP OF CURB UNLESS NOTED OTHERWISE. C. ALL PLANTING BEDS SHALL HAVE A MINIMUM OF 18" OF TOPSOIL, SOD AREAS A MINIMUM OF 12" OF
- TOPSOIL. SPREAD, COMPACT AND FINE GRADE TOPSOIL TO A SMOOTH AND UNIFORM GRADE. D. RE-USE EXISTING SURFACE TOPSOIL WHERE POSSIBLE. VERIFY SUITABILITY OF SURFACE SOIL TO PRODUCE TOPSOIL MEETING REQUIREMENTS AND AMEND WHEN NECESSARY. TOPSOIL SHALL BE A LOOSE, FRIABLE, SANDY LOAM. CLEAN AND FREE OF TOXIC MATERIALS. NOXIOUS WEEDS. WEED SEEDS. ROCKS. GRASS OR OTHER FOREIGN MATERIAL AND A PH OF 5.5 TO 7.0. IF ON-SITE TOPSOIL DOES NOT MEET THESE MINIMUM STANDARDS, CONTRACTORS ARE RESPONSIBLE TO EITHER: A) PROVIDE APPROVED IMPORTED TOPSOIL, OR B.) IMPROVE ON-SITE TOPSOIL WITH METHODS APPROVED BY LANDSCAPE ARCHITECT. SUPPLEMENT WITH IMPORTED TOPSOIL WHEN QUANTITIES ARE INSUFFICIENT. CLEAN TOPSOIL OF ROOTS, PLANTS, SODS, STONES, CLAY LUMPS AND OTHER EXTRANEOUS MATERIALS HARMFUL TO PLANT GROWTH.
- E. IF IMPORTED TOPSOIL FROM OFF-SITE SOURCES IS REQUIRED, PROVIDE NEW TOPSOIL THAT IS FERTILE, FRIABLE, NATURAL LOAM, SURFACE SOIL, REASONABLY FREE OF SUBSOIL, CLAY LUMPS, BRUSH, WEEDS AND OTHER LITTER, AND FREE OF ROOTS, STUMPS, STONES LARGER THAN 2 INCHES IN ANY DIMENSION, AND OTHER EXTRANEOUS OR TOXIC MATTER HARMFUL TO PLANT GROWTH. F. OBTAIN TOPSOIL FROM LOCAL SOURCES OR FROM AREAS HAVING SIMILAR SOIL CHARACTERISTICS TO THAT
- FOUND AT PROJECT SITE. OBTAIN TOPSOIL ONLY FROM NATURALLY, WELL-DRAINED SITES WHERE TOPSOIL OCCURS IN A DEPTH OF NOT LESS THAN 4 INCHES. G. ALL LANDSCAPE AREAS SHALL BE WEED FREE AT THE TIME OF LANDSCAPE INSTALLATION.REMOVE ALL
- ROOTS, WEEDS, ROCKS AND FOREIGN MATERIAL ON THE SURFACE. H. NEW TREE PLANTING, SEE DETAIL 1&2/PUD 7. CONTRACTOR SHALL STAKE ALL TREES DEEMED NECESSARY, I.E..... FROM BEING BLOWN OVER, PLANTED WITH LOOSE ROOT BALL, ETC. CONTRACTOR'S OPTION.
- NEW SHRUB PLANTING. SEE DETAIL 3/PUD 7. J. ALL PLANT MATERIAL SHALL CONFORM TO THE AMERICAN NURSERYMAN STANDARDS FOR TYPE AND SIZE SHOWN. PLANTS WILL BE REJECTED IF NOT IN A SOUND AND HEALTHY CONDITION.
- K. ALL PLANT MATERIAL SHALL BE GUARANTEED FOR A PERIOD OF ONE YEAR BEGINNING AT THE DATE OF SUBSTANTIAL COMPLETION. REPLACE ALL PLANT MATERIAL FOUND DEAD OR NOT IN A HEALTHY CONDITION IMMEDIATELY WITH THE SAME SIZE AND SPECIES AT NO COST TO THE OWNER. L. TREE PIT BACKFILL PLANTING MIX: BLEND TOPSOIL AND SOIL AMENDMENTS AND FERTILIZER FOR TREE PIT
- BACKFILL AT THE FOLLOWING RATES. BLEND AMENDMENTS THOROUGHLY WITH SOIL BACKFILL. TREE PITS SHALL BE 5'x5'x1.5' (37.5 CF/ 1.5 CY). L.A. APPLICATION RATES:
- L.A.A. HUMIC ACID: 25 LBS PER TREE PIT L.A.B. COMMERCIAL GRADE COMPOST - 10 CUBIC FEET PER TREE PIT
- L.A.C. PLANTING TABLET FERTILIZER 4 TABLETS PER TREE PIT L.A.D. CALCIFIED DIATOMACEOUS EARTH - 75 LBS PER TREE PIT
- M. SHRUB PIT BACKFILL PLANTING MIX: BLEND TOPSOIL AND SOIL AMENDMENTS AND FERTILIZER FOR SHRUB PIT BACKFILL AT THE FOLLOWING RATES. BLEND AMENDMENTS WITH THOROUGHLY WITH SOIL BACKFILL. SHRUB PITS SHALL BE 2.5'x2.5'x1' (6.25 CF/ 0.25 CY).
- M.A. APPLICATION RATES: M.A.A. HUMIC ACID: 2 LBS PER SHRUB PIT
- COMMERCIAL GRADE COMPOST 2 CUBIC FEET PER SHRUB PIT
- PLANTING TABLET FERTILIZER 2 TABLETS PER SHRUB PIT
- CALCIFIED DIATOMACEOUS EARTH 15 LBS PER SHRUB PIT N. IMMEDIATELY CLEAN UP ANY TOPSOIL OR OTHER DEBRIS ON THE SITE CREATED FROM LANDSCAPE OPERATIONS AND DISPOSE OF PROPERLY OFF SITE.
- CONTRACTOR SHALL SUBMIT MATERIAL SAMPLES FOR LANDSCAPE ROCK MULCH TO LANDSCAPE ARCHITECT FOR APPROVAL PRIOR TO PROCUREMENT. LANDSCAPE BOULDERS, PHOTO SUBMITTAL IS ADEQUATE. FOR ROCK MULCH, SUBMIT 1 GALLON BAG SAMPLE TO OWNER.

Automatic Underground Irrigation Notes:

- A. ALL LANDSCAPED AREAS SHALL HAVE AN AUTOMATIC UNDERGROUND SPRINKLER SYSTEM WHICH ENSURES COMPLETE COVERAGE AND PROPERLY ZONED FOR REQUIRED WATER USES.
- B. EACH HYDROZONE IS TO BE IRRIGATED WITH SEPARATE INDIVIDUAL STATIONS. C. POP-UP SPRINKLER HEADS SHALL HAVE A MINIMUM RISER HEIGHT OF 18" AT PLANTER BEDS, 6" AT LAWN
- D. PLANTER BEDS ARE TO HAVE DRIP IRRIGATION SYSTEMS WITH DRIP CONTROL ZONE KIT AND 150 MESH
- E. ELECTRONIC WATER DISTRIBUTION/ TIMING CONTROLLERS ARE TO BE PROVIDED. MINIMUM CONTROLLER
- REQUIREMENTS ARE AS FOLLOWS: E.A. PRECISE INDIVIDUAL STATION TIMING
- E.B. RUN TIME CAPABILITIES FOR EXTREMES IN PRECIPITATION RATES
- E.C. AT LEAST ONE PROGRAM FOR EACH HYDROZONE E.D. SUFFICIENT MULTIPLE CYCLES TO AVOID WATER RUN-OFF
- E.E. POWER FAILURE BACKUP FOR ALL PROGRAMMED INDIVIDUAL VALVED WATERING STATIONS WILL BE DESIGNED AND INSTALLED TO PROVIDE WATER TO RESPECTIVE HYDRO-ZONES. F. INDIVIDUAL VALVED WATERING STATIONS WILL BE DESIGNED AND INSTALLED TO PROVIDE WATER TO
- RESPECTIVE HYDRO-ZONES. G. THE IRRIGATION SYSTEM SHALL BE DESIGNED TO PROVIDE 100% COVERAGE WITH HEAD TO HEAD SPACING
- OR TRIANGULAR SPACING AS APPROPRIATE. H. SPRINKLER HEADS SHALL BE ADJUSTED TO REDUCE OVERSPRAY ONTO IMPERVIOUS SURFACES SUCH AS
- SIDEWALKS, DRIVEWAYS, AND PARKING AREA. I. EACH VALVE SHALL BE INSTALLED IN A VALVE BOX LARGE ENOUGH TO ALLOW FOR MAINTENANCE AND REMOVAL. ONLY ONE VALVE PER BOX.

Project Calculations:

A.	NON-RESIDENTIAL STREET TREE CALCULATIONS:						
		LINEAR FOOTAGE	TREES REQUIRED	TREES PROVIDED			
			_				
	E. PINE STREET:	119 LF	3	3			
	S. 1ST AVENUE:	240 LF	6	6 (INCL 1 RETAINE			
	TOTAL STREET TREES		9	9			
B.	LANDSCAPE BUFFER CALCULATIONS:						
		BUFFER/TREES REQ	UIRED B	UFFER/TREES PROVIDED			
	NORTH BUFFER TO RESIDENTIAL*:	8-FT/NOT SPECIFIED	12	2-FT/4 TREES			
C.	OPEN SPACE CALCULATIONS:						
		OPEN SPACE PROVI	DED**:				
	OPEN SPACE AREA	±12,921 SF 44.99					
	(EXCL PLANTERS IN ROW):	, ,					
D.	OVERALL LANDSCAPE						
		TOTAL TREES RETA	INED: 2				

TOTAL TREE SPECIES PROVIDED: 8 * NON-RESIDENTIAL BUILDINGS WITHIN TN ZONING DISTRICT MUST PROVIDE A 6-FOOT TALL, YEAR ROUND VISUAL SCREEN WHEN ADJACENT TO RESIDENTIAL PARCELS. PROJECT'S NORTH WALL TO PROVIDE A

TOTAL TREES PROPOSED: 18

MINIMUM OF 6' TALL SCREENING TO EXISTING RESIDENTIAL PROPERTY FRONTING ON WALNUT. ** INCLUDES $\pm 6,820$ SF OF SOFTSCAPE/PLANTERS AND $\pm 6,101$ HARDSCAPE/PLAZA SPACE.

NOT FOR CONSTRUCTION






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checked: MTA


application

Landscape Plan - Main Level

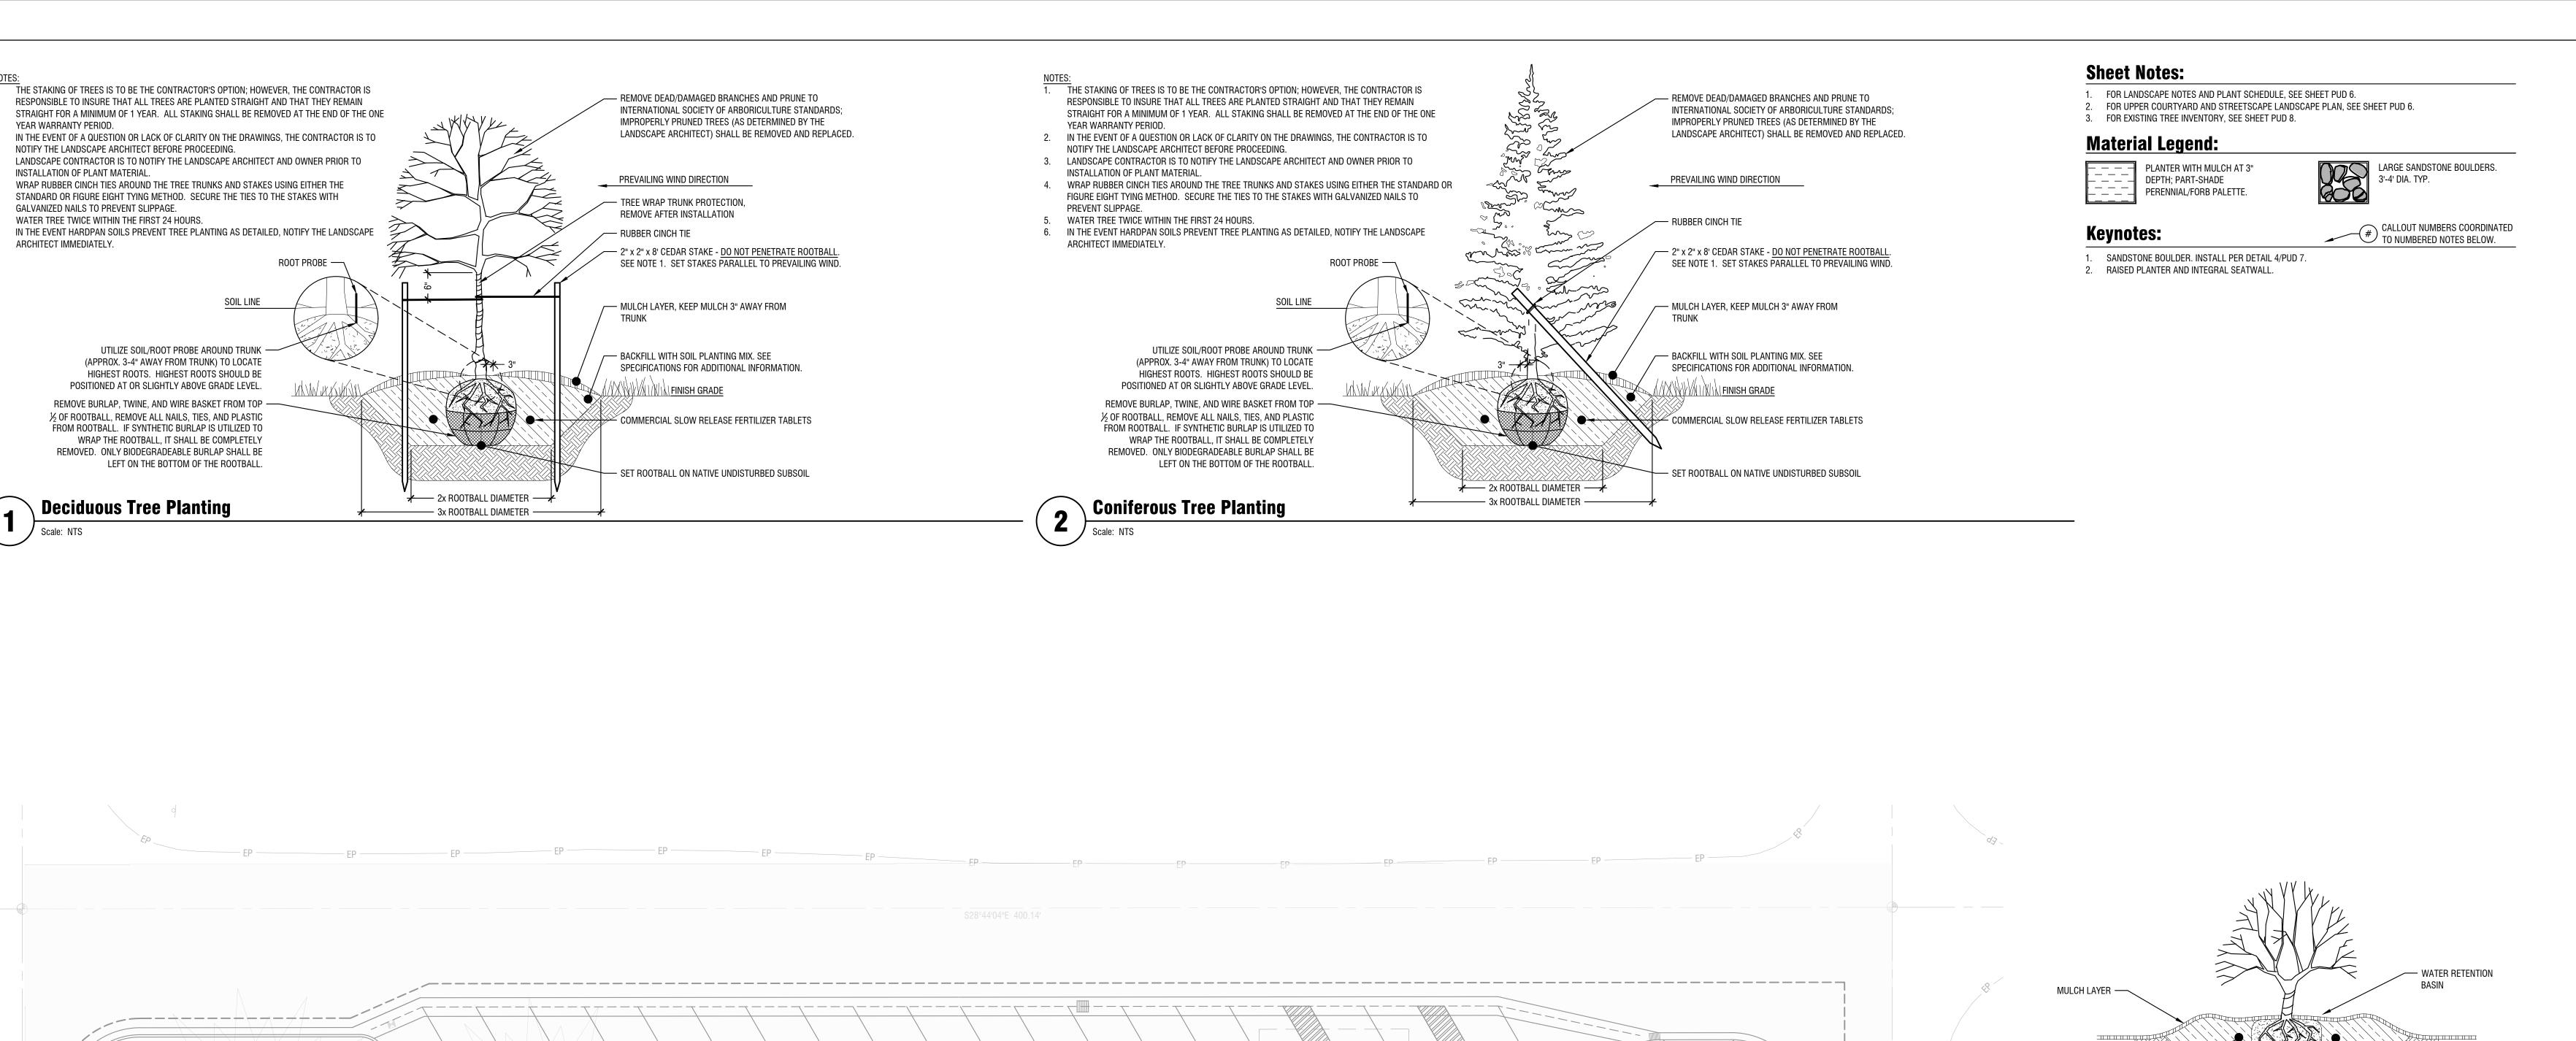


UPPER COURTYARD AND

STREETSCAPE - SEE SHEET L1.00

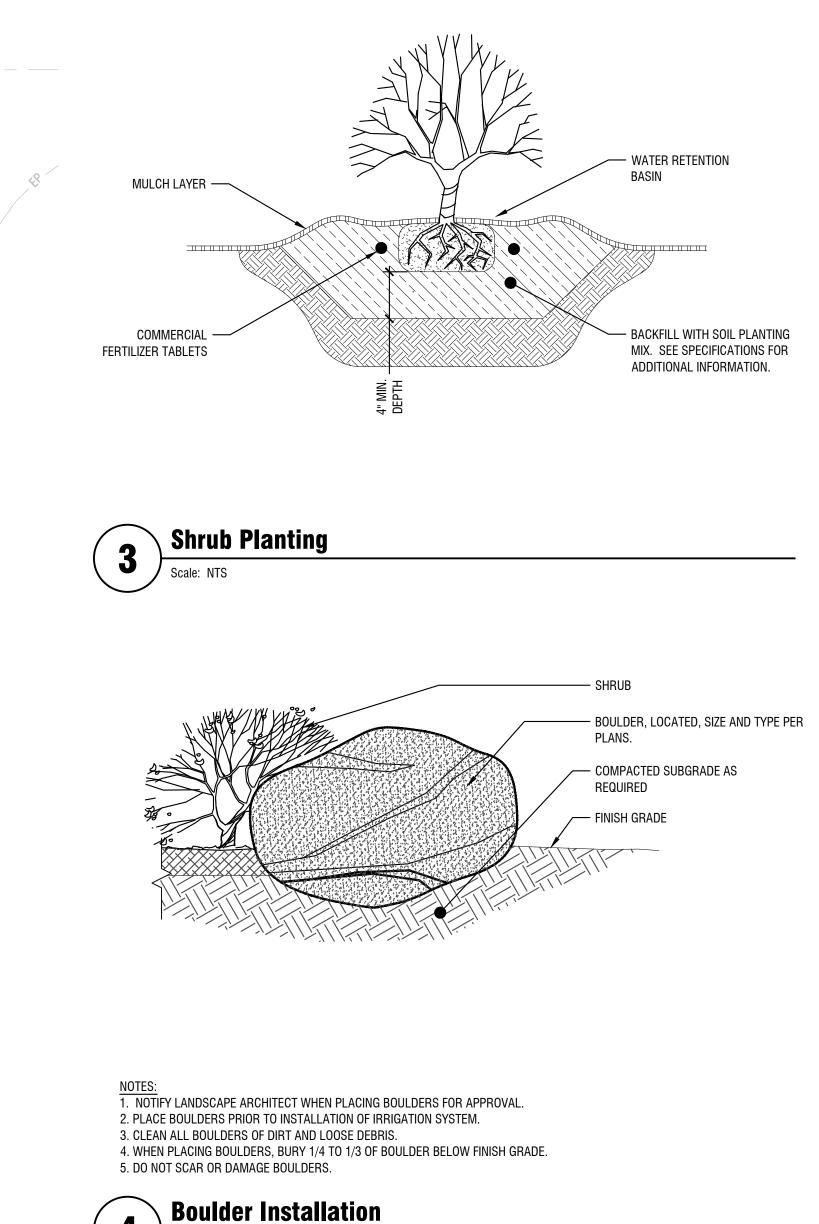

Scale: NTS

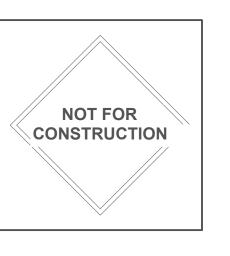





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311 1st avenue

evision: o. desc. date

project: 230706 date: 12.19.24 drawn: KW/CL/TC checked: MTA

pud application

Plan - Lower Level

Landscape

DETAILED TREE INVENTORY							
KEYNOTE #	DBH	BOTANICAL NAME	COMMON NAME	PUBLIC OR PRIVATE TREE	LANDSCAPE ARCHITECT NOTES	TREE MITIGATION REQUIRED	
1	2'-11"	PICEA ABIES	NORWAY SPRUCE	PUBLIC	CONIFERS ARE NOT INCLUDED IN THE CITY OF HAILEY'S RECOMMENDED STREET TREE LIST DUE TO "PROBLEMS WITH CLEARANCE AND SHADING OF STREETS AND SIDEWALKS IN WINTER." IT IS ASSUMED THAT THIS TREE, THEREFORE, IS NOT A DESIRABLE SPECIMEN AS IT DOESN'T MEET THE HAILEY TREE COMMITTEE'S GUIDANCE PUBLISHED 2/10/2022.	TO BE DETERMINED; ASSUMED TO BE NONE AS IT DOES NOT COMPLY WITH THE CITY OF HAILEY'S TREE ORDINANCE.	
2	2'-9"	PICEA ABIES	NORWAY SPRUCE	PRIVATE			
3	2'-6"	PICEA ABIES	NORWAY SPRUCE	PRIVATE			
4	1'-8"	MALUS Spp.	CRABAPPLE	PRIVATE			
5	2'-6"	PICEA ABIES	NORWAY SPRUCE	PUBLIC		NONE; TREE IS TO BE RETAINED	
6	1'-6"	PICEA ABIES	NORWAY SPRUCE	PRIVATE			
7	1'-4"	MALUS Spp.	CRABAPPLE	PRIVATE			
8	2'-4"	PICEA ABIES	NORWAY SPRUCE	PRIVATE			

			DETAILED TR	EE INVENTORY		
KEYNOTE #	DBH	BOTANICAL NAME	COMMON NAME	PUBLIC OR PRIVATE TREE	LANDSCAPE ARCHITECT NOTES	TREE MITIGATION REQUIRED
1	2'-11"	PICEA ABIES	NORWAY SPRUCE	PUBLIC	CONIFERS ARE NOT INCLUDED IN THE CITY OF HAILEY'S RECOMMENDED STREET TREE LIST DUE TO "PROBLEMS WITH CLEARANCE AND SHADING OF STREETS AND SIDEWALKS IN WINTER." IT IS ASSUMED THAT THIS TREE, THEREFORE, IS NOT A DESIRABLE SPECIMEN AS IT DOESN'T MEET THE HAILEY TREE COMMITTEE'S GUIDANCE PUBLISHED 2/10/2022.	TO BE DETERMINED; ASSUMED TO BE NONE AS IT DOES NOT COMPLY WITH THE CITY OF HAILEY'S TREE ORDINANCE.
2	2'-9"	PICEA ABIES	NORWAY SPRUCE	PRIVATE		
3	2'-6"	PICEA ABIES	NORWAY SPRUCE	PRIVATE		
4	1'-8"	MALUS Spp.	CRABAPPLE	PRIVATE		
5	2'-6"	PICEA ABIES	NORWAY SPRUCE	PUBLIC		NONE; TREE IS TO BE RETAINED
6	1'-6"	PICEA ABIES	NORWAY SPRUCE	PRIVATE		
7	1'-4"	MALUS Spp.	CRABAPPLE	PRIVATE		
0	01.41	DIOCA ADICO	NODWAY ODDUGE	DDN/ATE		

Sheet Notes:


- A. ALL TREES OUTSIDE OF PROJECT'S DEMOLITION LIMITS ARE TO BE RETAINED. B. PRELIMINARY TREE ANALYSIS SURVEY AND MITIGATION PLAN WAS CREATED BY
- THE LAND GROUP (12/05/2024). C. ARBORIST REPORT TO BE COMPLETED AT TIME OF DESIGN REVIEW APPLICATION.
- D. ARBORIST CONTACT: TBD AT TIME OF DESIGN REVIEW APPLICATION.

Existing Trees:

TOTAL PUBLIC TREES TO BE REMOVED: 1 (35" DBH) TOTAL PRIVATE TREES TO BE REMOVED: 5

TREES REQUIRING MITIGATION: TBD TOTAL MITIGATION (CALIPER INCHES) PROVIDED ON LANDSCAPE PLAN: 45 IN.

Demolition Legend:

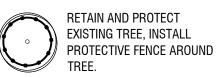




Tree Protection Notes:

- A. PROTECT THE CRITICAL ROOT ZONE OF THE TREES TO BE RETAINED ON SITE: (NOTE: CRITICAL ROOT ZONE IS THE AREA DIRECTLY BELOW THE DRIP LINE OF THE TREE.)
- A.A. CONSTRUCT PROTECTIVE FENCING OF CHAIN-LINK AROUND THE CRITICAL ROOT ZONE PRIOR TO DEMOLITION OR CONSTRUCTION.
- A.B. DO NOT ALLOW COMPACTION BY EQUIPMENT TRAFFIC DURING CONSTRUCTION OR DURING
- DEMOLITION. A.C. DO NOT ALLOW CEMENT TRUCKS TO RINSE WITHIN THE PROTECTION AREA, ANYWHERE THAT TREE ROOTS EXIST OR IN PLANNED PLANTING BEDS.
- A.D. DO NOT STOCKPILE MATERIALS, DEBRIS OR DIRT WITHIN THE TREE PROTECTION AREA. A.E. MAINTAIN WATERING WITHIN THE CRITICAL ROOT ZONE FROM MID-APRIL TO MID-OCTOBER AT THE RATE OF NOT LESS THAN THE EQUIVALENT OF 1-1/2" OF WATER OVER THE ENTIRE AREA PER WEEK.
- A.F. DO NOT TRENCH, EXCAVATE, FILL OR OTHERWISE DISTURB THE SOIL WITHIN THE CRITICAL ROOT ZONE. A.G. ADJUST PROPOSED IMPROVEMENT LOCATIONS AS REQUIRED TO AVOID DAMAGING TREE ROOTS.
- B. PROTECT THE CROWN AND TRUNK OF TREES TO BE RETAINED ON SITE: B.A. OPERATE EQUIPMENT IN SUCH A WAY AS TO AVOID CONTACT WITH TREE TRUNKS OR BRANCHES.
- B.B. PRUNING OF PUBLIC PROPERTY TREES SHALL BE PERFORMED BY A LICENSED ARBORIST. C. ALL TREES NOT IDENTIFIED FOR REMOVAL THAT ARE DAMAGED OR DESTROYED DURING CONSTRUCTION SHALL BE REPLACED USING THE FOLLOWING CRITERIA:

EXISTING TREE

1" TO 6" CALIPER......2X CALIPER OF TREE REMOVED 6" TO 12" CALIPER......1.5X CALIPER OF TREE REMOVED > 12" OR LARGER CALIPER......1X CALIPER OF TREE REMOVED

EXAMPLE: IF AN 8" CALIPER TREE IS REMOVED, AN ACCEPTABLE REPLACEMENT WOULD BE (3) 4" CALIPER TREES OR (4) 3" CALIPER TREES.

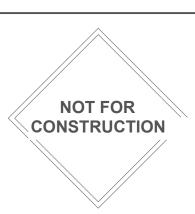







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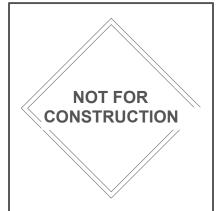
drawn: KW/CL, checked: MTA


application

Tree Inventory



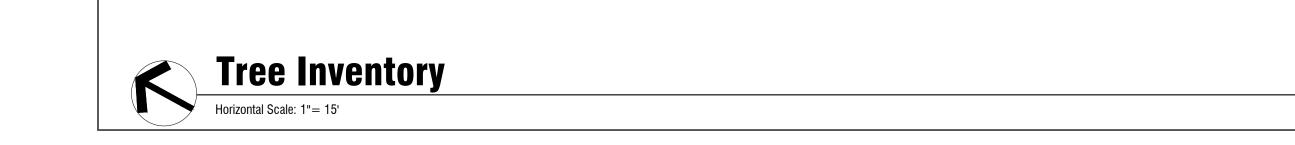

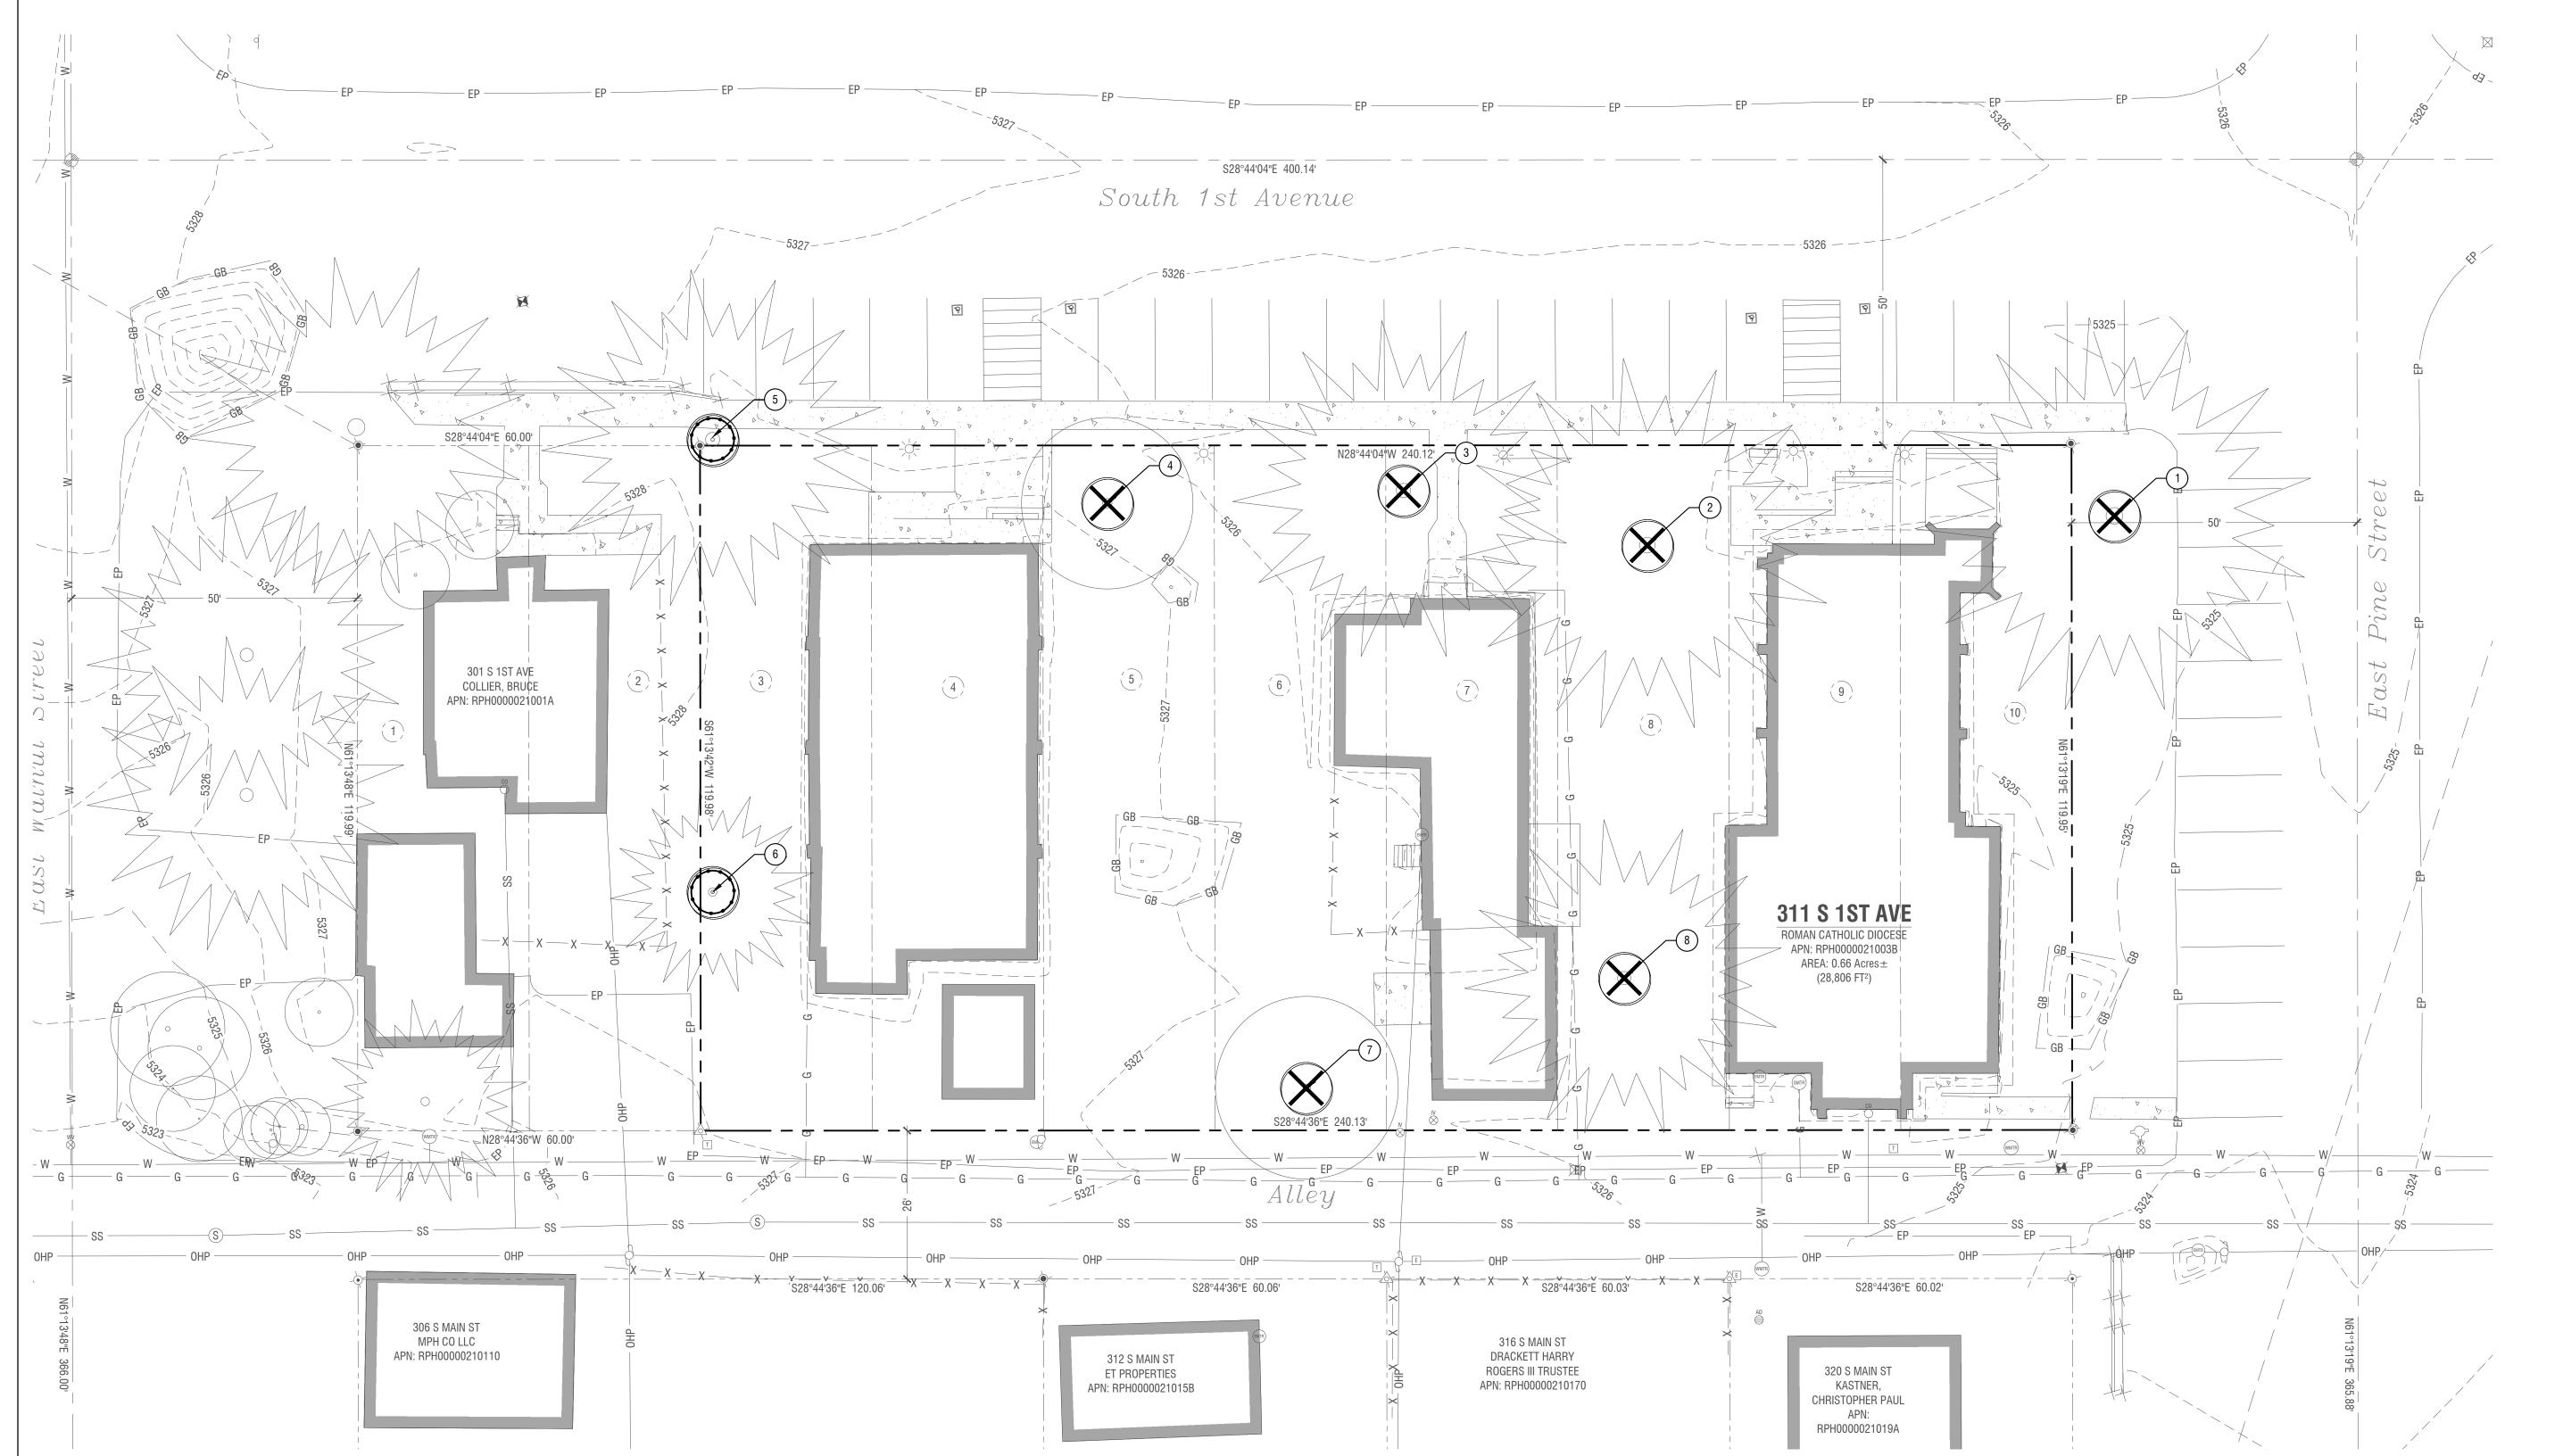

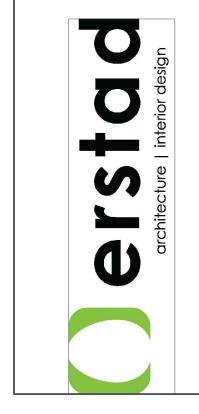

-START @ 7 PM-

MASS STARTING

Sunday



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Days of the Week

DONE @ 6PM-

BUSINESSES CLOSING

Legend:

RESIDENTIAL

ST CHARLES BORROMEO CATHOLIC CHURCH

BUSINESS

Wednesday Thursday


7 PM MASS INFLUX ——

Notes:

1. 1-BLOCK RADIUS AROUND THE CHURCH

Tuesday

- 1.1. IN A STUDY PUBLISHED BY AMERICAN JOURNAL OF PREVENTIVE MEDICINE. STATES THAT THE AVERAGE DISTANCE A US CITIZENS WILL WALK IS .25 MILES.
- 1.2. 1 BLOCK RADIUS IS EQUAL TO .125 MILES.
- 2. PARKING WITHIN RIGHT-OF-WAY PER BLOCK OF BUSINESS AND TRANSITIONAL ZONING. ESTIMATED TOTAL 404 PARKING STALLS.
- 2.1. DEVELOPED: 306
- 2.2. UNDEVELOPED: 98
- 3. PARKING CODE:
- 3.1. 17.09.040.01: RESIDENTIAL PARKING REQUIREMENTS:
 - 1.1.1. 2 SPACES PER DWELLING UNIT MINIMUM, 6 SPACES PER DWELLING UNIT MAXIMUM.
- 3.3. 17.09.040.02: COMMERCIAL, PROFESSIONAL, SERVICE, RECREATION AND ENTERTAINMENT:
- 1 SPACE PER 1,000 SQUARE FEET.
- 3.2. 17.09.040.05: INDUSTRIAL:
- 3.1.1. PUBLIC UTILITIES/PUBLIC SERVICES /ECT. = 1 SPACE PER 1,000 SQUARE FEET.
- ESTIMATED PARKING COUNTS ARE BASED ON BUSINESSES HOURS OF OPERATIONS AND PARKING CODE REQUIREMENTS.
- 1.1. 119 SPOTS TOTAL PER BUILDING MASS
- 5. ST CHARLES PARKING COUNTS BASED ON KNOWN CHURCH ACTIVITIES AND CODE REQUIREMENTS.
 - . 125 SPOTS TOTAL AT PEAK

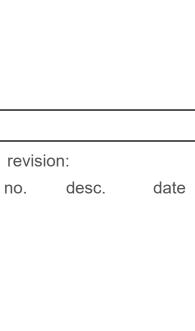

checked: MTA

pud

application

Parking Availability
PUD 9

Right-of-Way



DEVELOPED 17 PARKING STALLS

DEVELOPED 20 PARKING STALLS

UNDEVELOPED 16 PARKING STALLS

DEVELOPED 2 PARKING STALLS

DEVELOPED 3 PARKING STALLS

DEVELOPED 14 PARKING STALLS

E TUEL OFE ILE

OVERLAY DISTRICT

UNDEVELOPED 20 PARKING STALLS

DEVELOPED 12 PARKING STALLS

DEVELOPED 10 PARKING STALLS


DEVELOPED 20 PARKING STALLS

1 BLOCK RADIUS


- DOWNTOWN
RESIDENTIAL OVERLAY

DEVELOPED 12 PARKING STALLS

DEVELOPED 10 PARKING STALLS

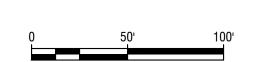



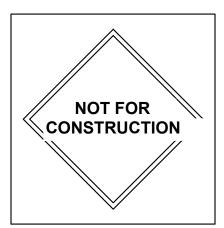





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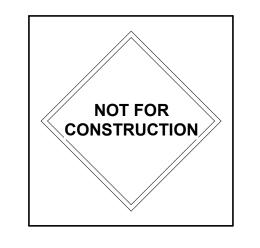
t. Charles Borromed 311 1st avenue

revision: no. desc. date

project: 230706
date: 12.19.24
drawn: KW/CL/TC
checked: MTA

pud
application

Phasing Exhibit





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OBL 82023

311 1st avenue hailey, idaho 83333

revision:

project: 230706 date: 10.02.24 drawn: Author checked: Checker

general notes


A. CONTRACTOR TO VERIFY ALL DIMENSIONS IN FIELD. NOTIFY ARCHITECT IF DISCREPANCIES ARE FOUND.
B. GYPSUM WALLBOARD APPLICATION & FINISHING AT ALL EXPOSED SURFACES TO COMPLY WITH SPECIFICATIONS.
C. UNLESS NOTED OTHERWISE, ALL EXTERIOR WALLS ARE DIMENSIONED TO FACE OF FOUNDATION / GRID LINE.
D. UNLESS NOTED OTHERWISE, ALL PARTITIONS ARE DIMENSIONED TO FACE OF STUD.

E. UNLESS DIMENSIONED OTHERWISE, INTERIOR DOORS SHALL BE LOCATED 4" FROM ADJACENT PARTITION.

pud application

basement floor plan


a2.10

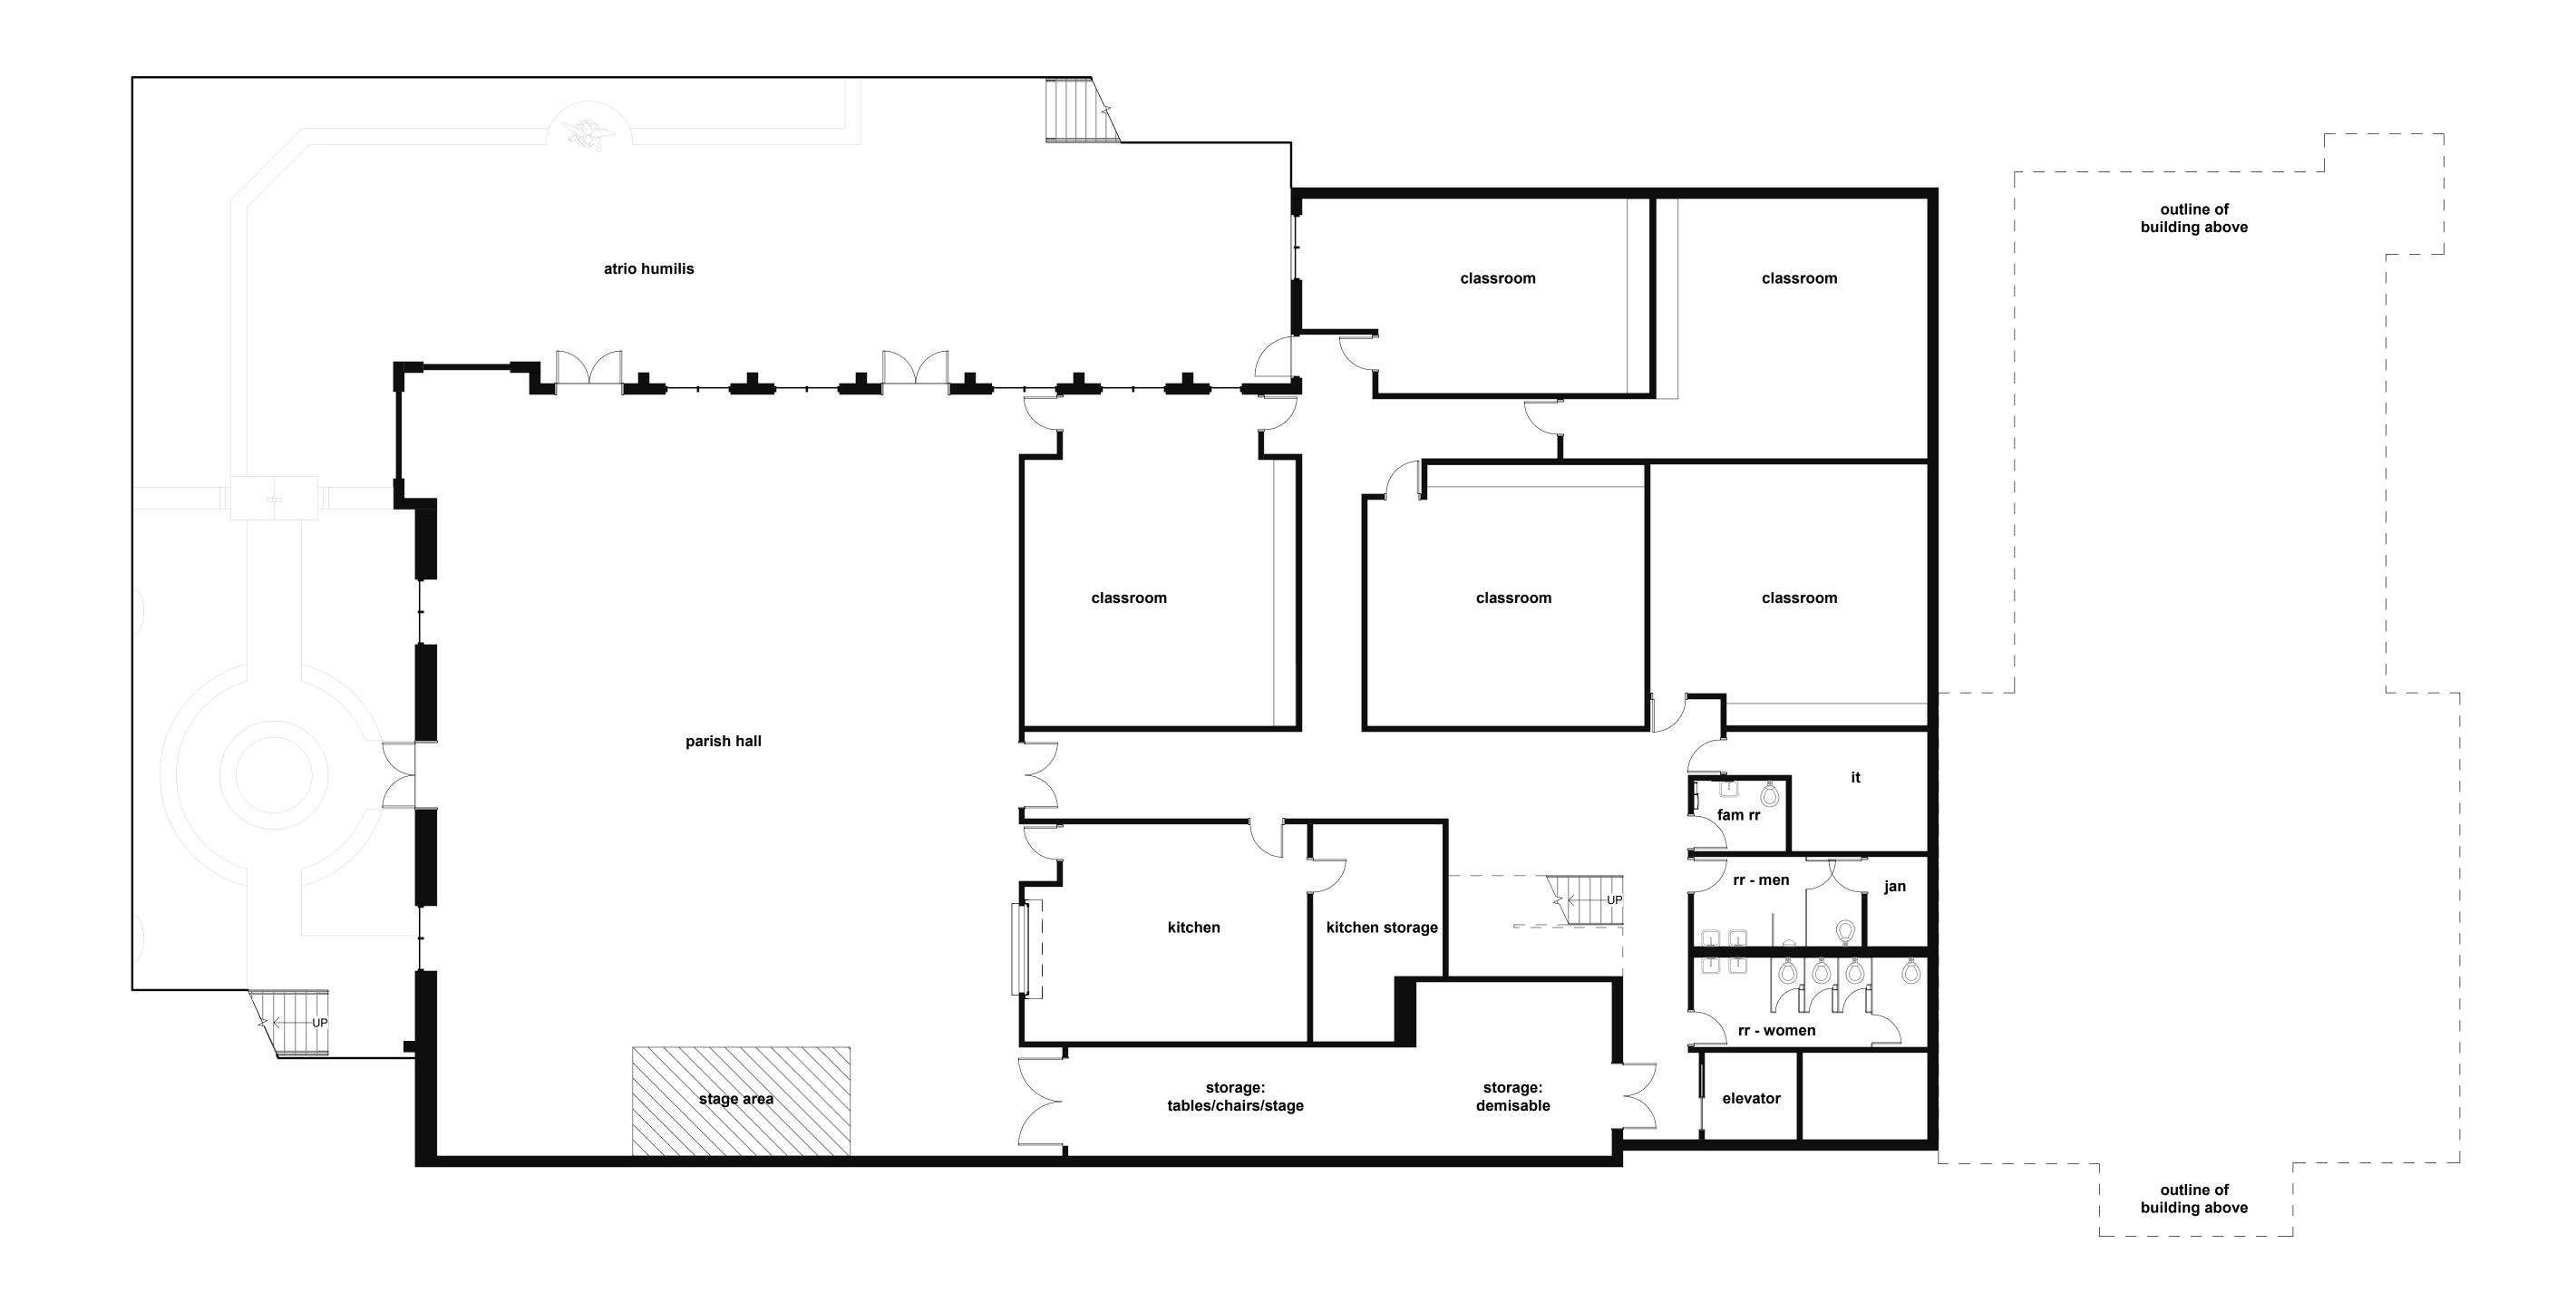


keynote

basement

1/8" = 1'-0"

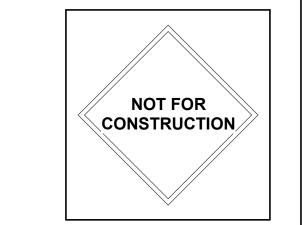

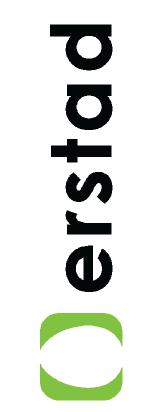


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project: 230706 date: 10.02.24 drawn: Author

checked: Checker application

first floor

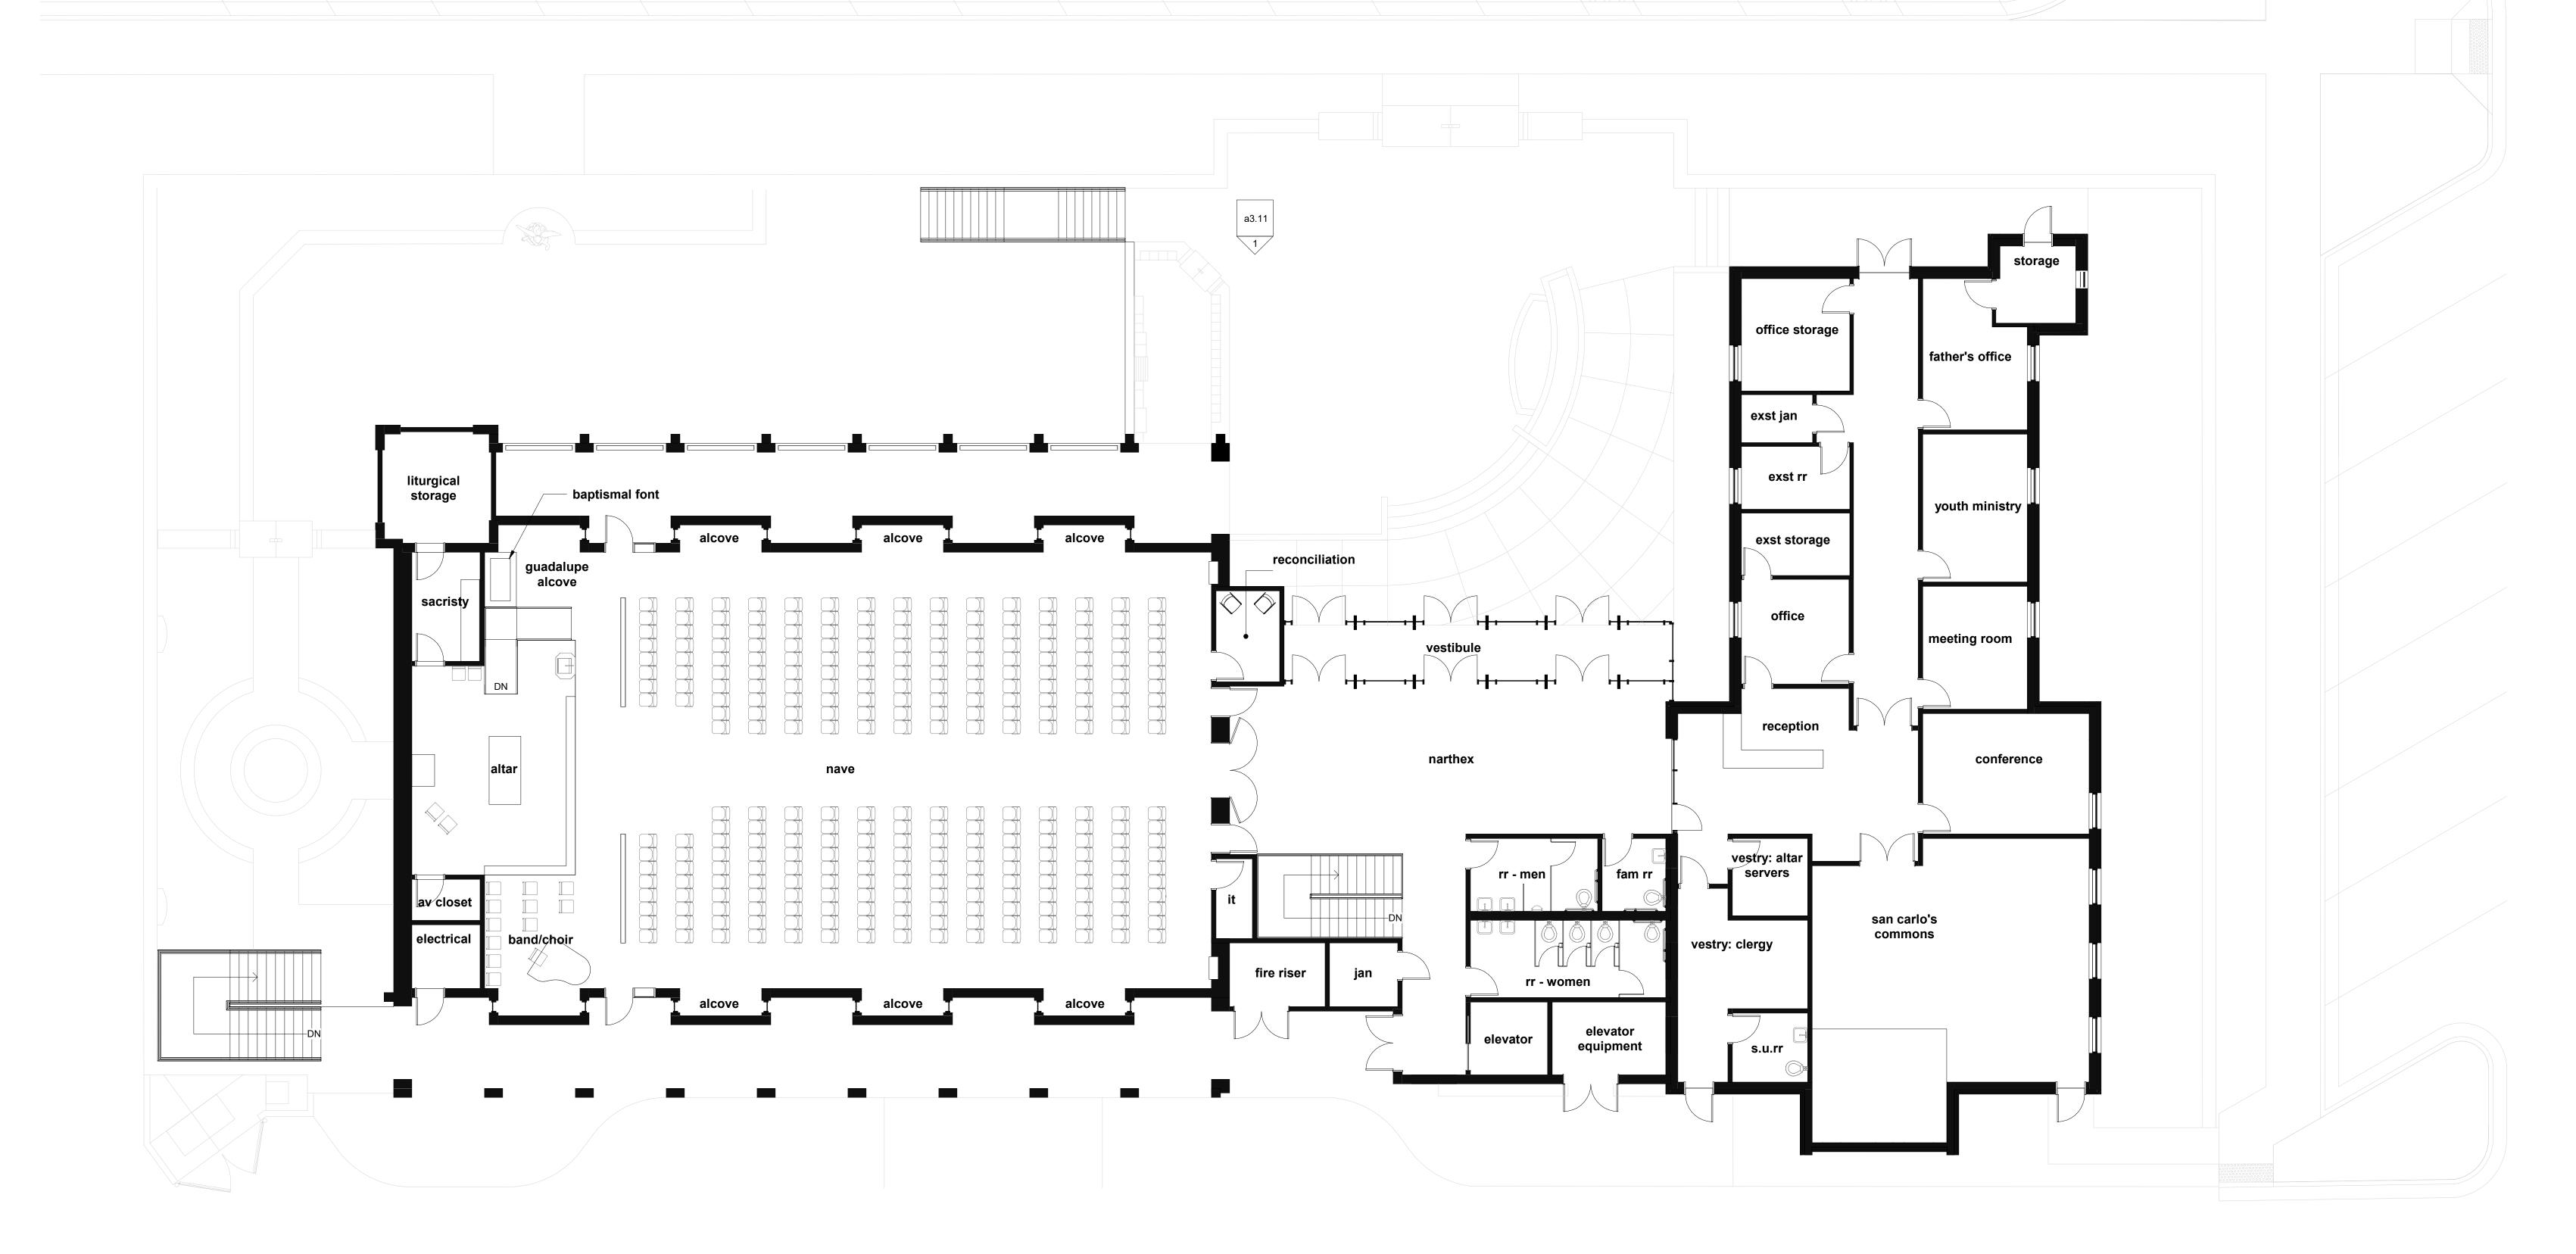

first floor - addition

1/8" = 1'-0"

a3.11 2

keynote

general notes

A. CONTRACTOR TO VERIFY ALL DIMENSIONS IN FIELD. NOTIFY ARCHITECT IF DISCREPANCIES ARE FOUND.
B. GYPSUM WALLBOARD APPLICATION & FINISHING AT ALL EXPOSED SURFACES TO COMPLY WITH SPECIFICATIONS.
C. UNLESS NOTED OTHERWISE, ALL EXTERIOR WALLS ARE DIMENSIONED TO FACE OF FOUNDATION / GRID LINE.
D. UNLESS NOTED OTHERWISE, ALL PARTITIONS ARE DIMENSIONED TO FACE OF STUD.


E. UNLESS DIMENSIONED OTHERWISE, INTERIOR DOORS SHALL BE LOCATED 4" FROM ADJACENT PARTITION.




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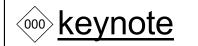
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north
1/8" = 1'-0"



general notes

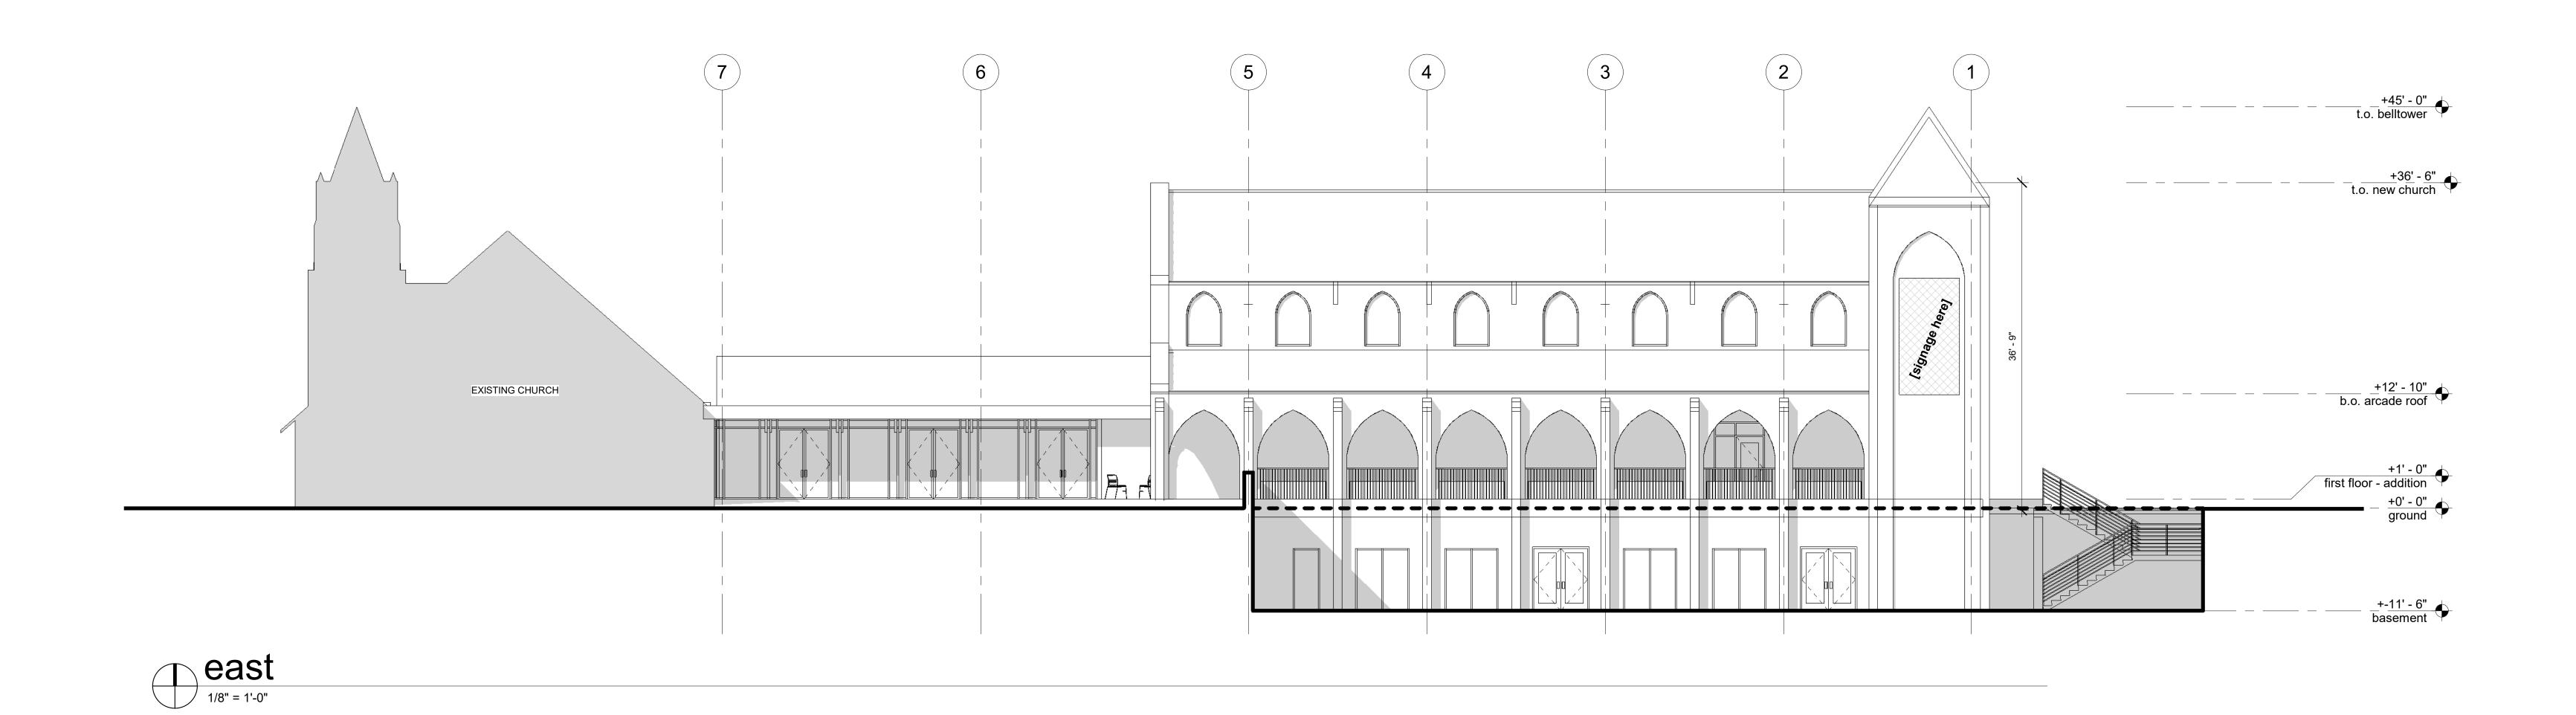- A. DO NOT SCALE HATCH PATTERNS. FOR MATERIAL REPRESENTATION
- ONLY.

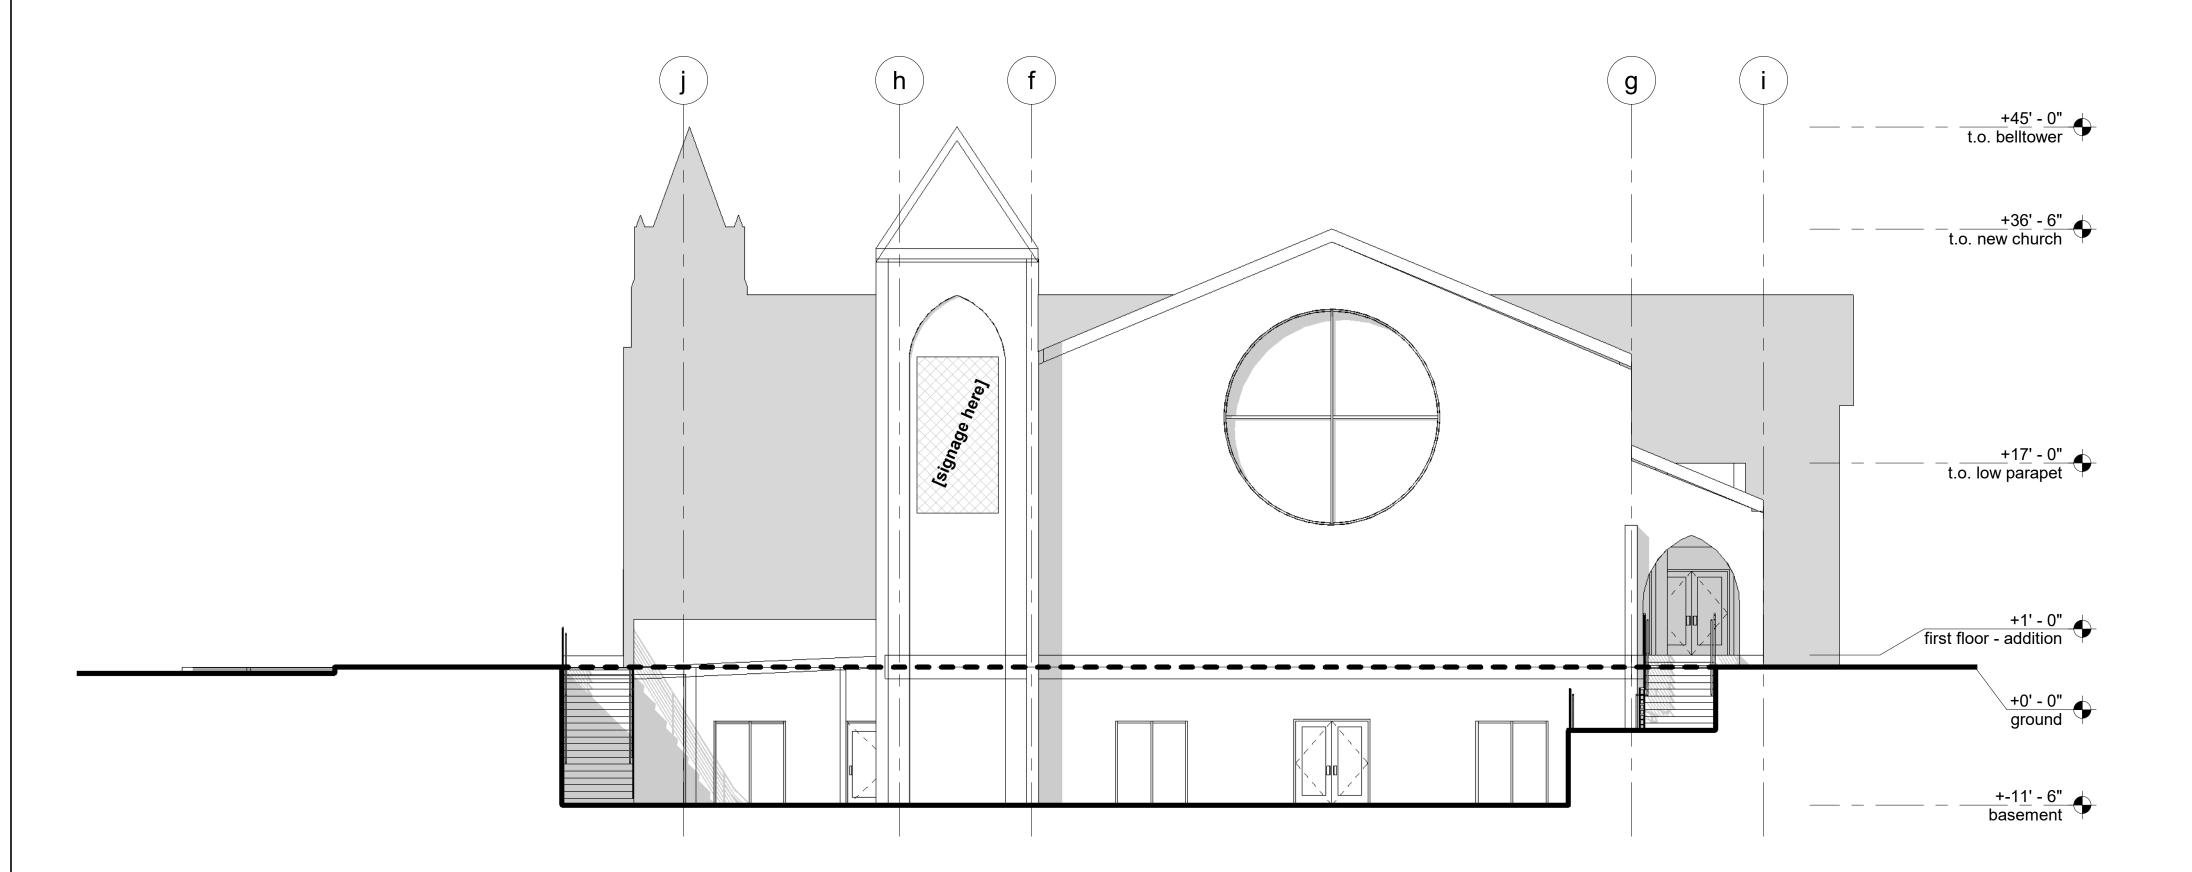 B. PAINT ALL EXPOSED ROOF PENETRATIONS TO MATCH ROOF.
 C. EXTERIOR JOINTS AROUND WINDOW AND DOOR FRAMES, OPENINGS
 BETWEEN WALLS AND FOUNDATIONS, BETWEEN WALLS AND ROOF,
 BETWEEN WALLS AND PANELS, AT PENETRATIONS OF UTILITY SERVICE
 THROUGH WALLS, FLOORS, AND ROOFS, AND ALL OTHER SUCH OPENINGS INTO BUILDINGING SHALL BE SEALED, CAULKED, GASKETED, OR WEATHERSTRIPPED TO LIMIT AIR LEAKAGE AROUND THEIR PERIMETER WHEN IN CLOSED POSITION.

project: 230706 date: 10.02.24 drawn: Author checked: Checker

application

exterior elevations



Existing vs. Proposed Comparison St. Charles Borromeo Catholic Church **Community Open House Follow-Up**

EX-1

Project No.: 121154 Date of Issuance: 12/13/2024